


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GROUND FLOOR PLAN
SCALE 1:100

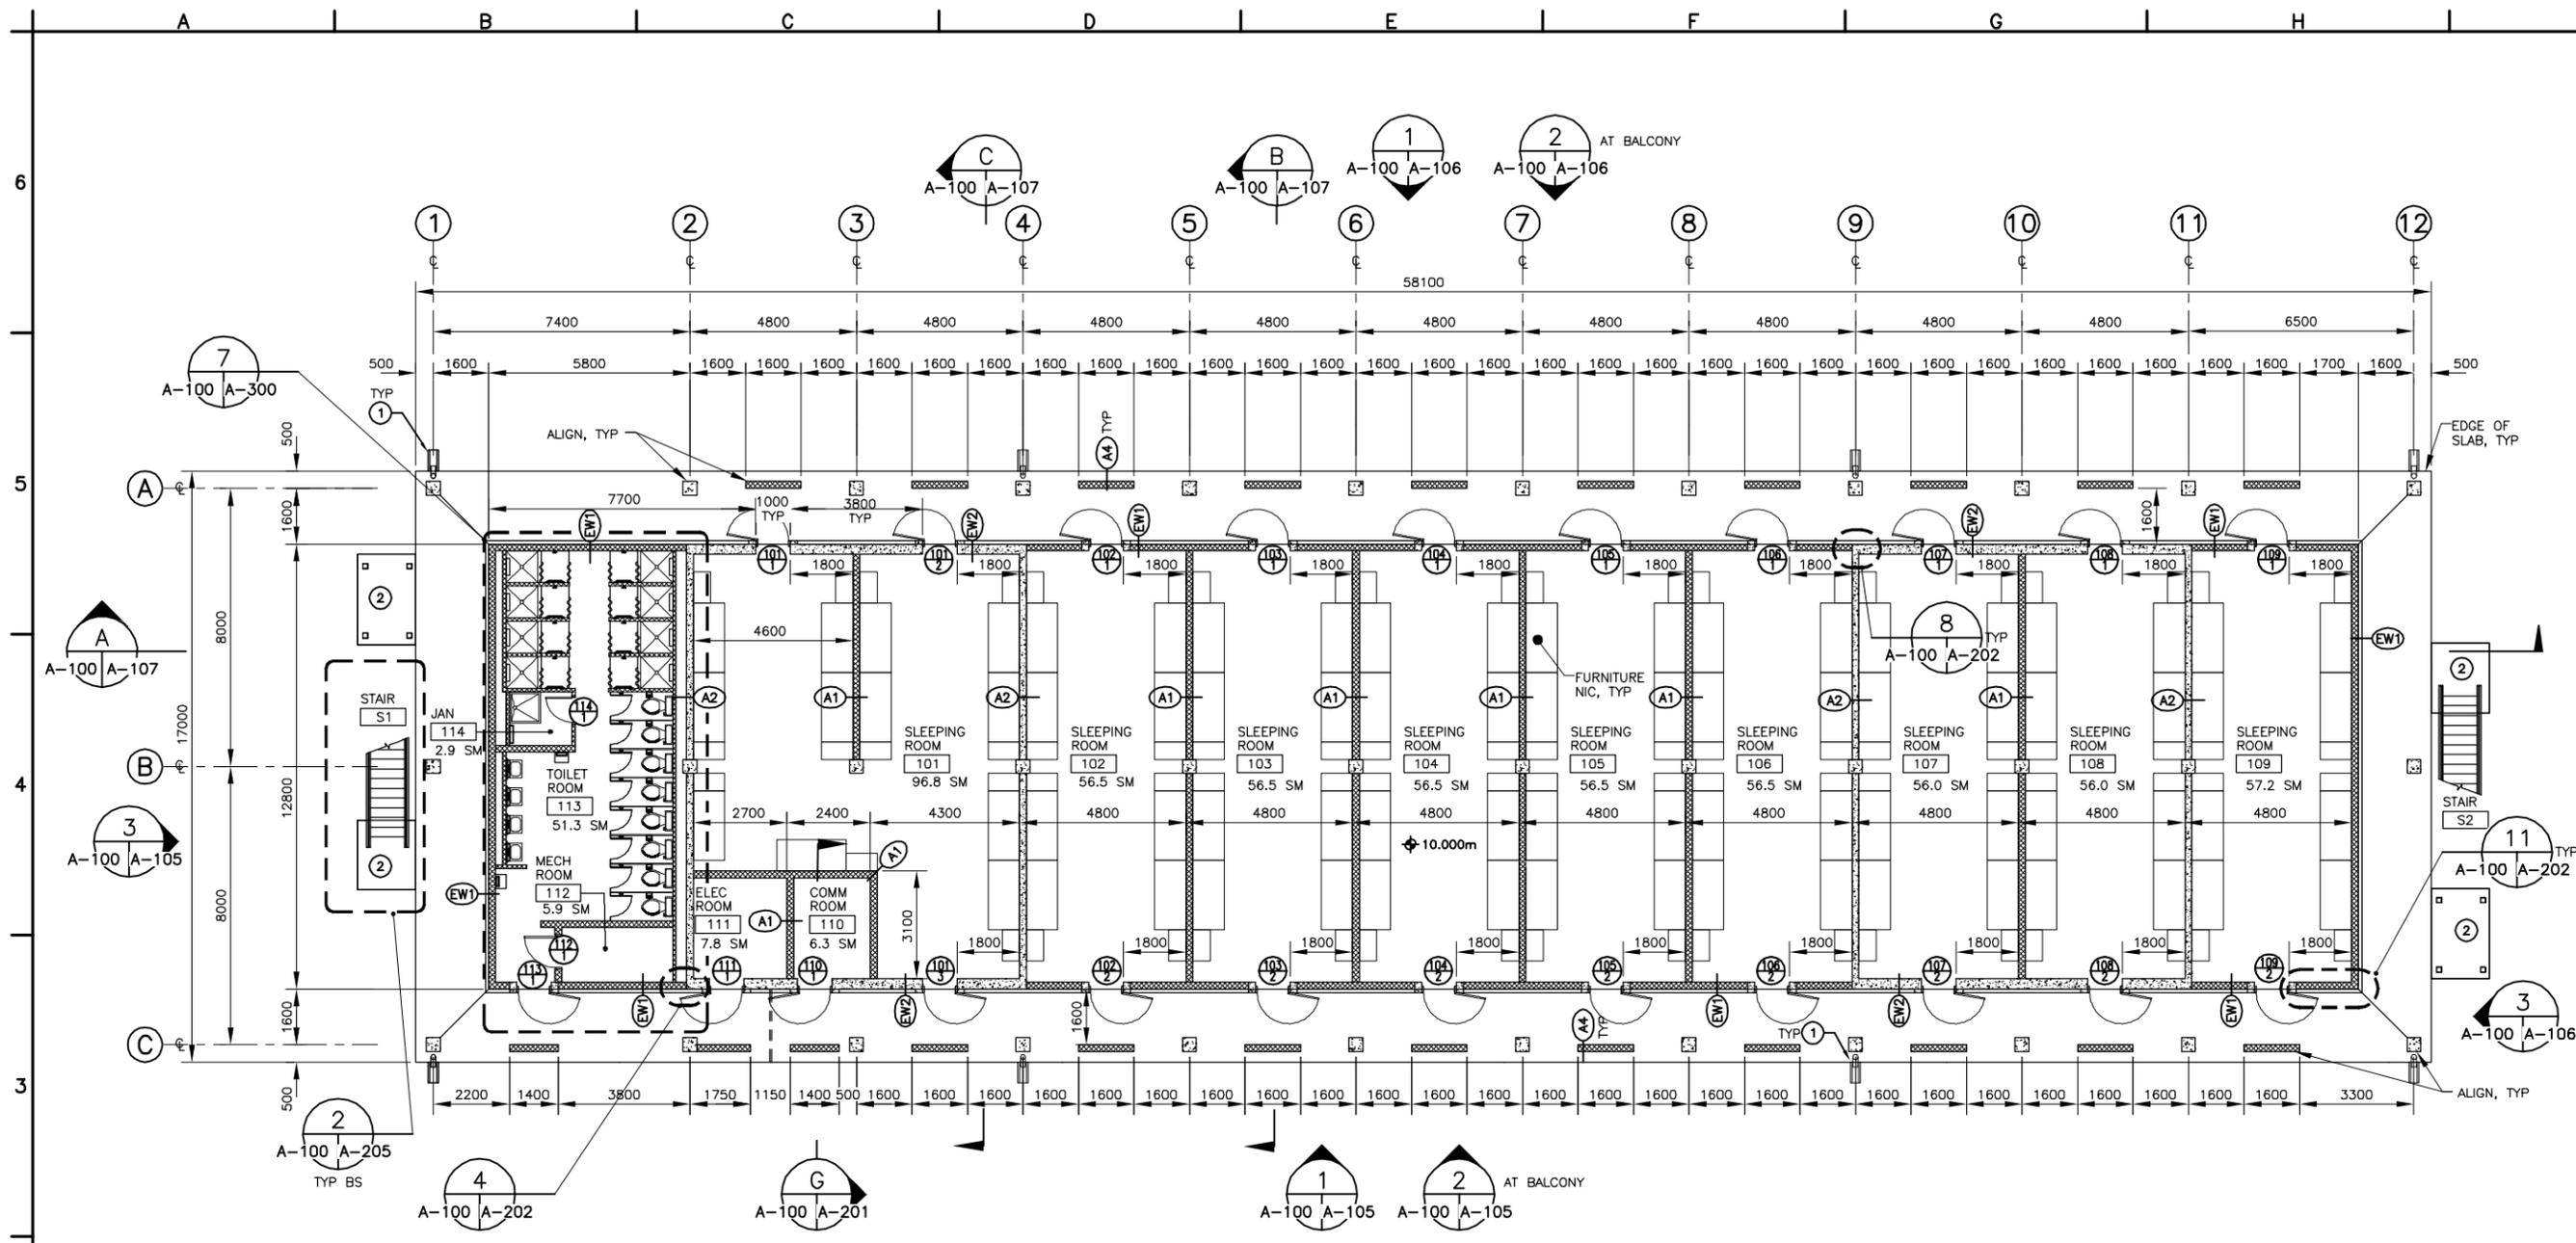

GENERAL NOTES:

1. UNO, ALL MASONRY/ROUGH OPENINGS FOR DOORS ARE 100mm FROM FACE OF MASONRY.
2. REFER TO DRAWING A-202 FOR WALL TYPE AND PARTITION TYPE DETAILS.
3. REFER TO LIFE SAFETY PLANS FOR FIRE RATINGS
4. REFER TO MECH, PLUMB, FP, FA, ELEC, AND TC DWGS FOR PENETRATION LOCATIONS, SEE S/A-203 FOR PIPE PENETRATION DETAIL AND 6/M-201 FOR DUCT PENETRATION DETAIL.

SPECIFIC NOTES:

- ① SPLASH BLOCK. SEE DETAIL 7/A-202.
- ② POURED CONCRETE PAD, REFER TO CIVIL AND STRUCTURAL DRAWINGS.

THESE DRAWINGS ARE "NOT APPROVED FOR CONSTRUCTION" SINCE THESE ARE BASED UPON ASSUMED CONDITIONS. THE CONTRACTOR SHALL NOT PROCEED WITH CONSTRUCTION UNTIL THE ASSUMED CONDITIONS ARE VALIDATED AND APPROVAL IS RECEIVED FROM THE CONTRACTING OFFICER.



CORRECTED FINAL DESIGN SUBMITTAL

SYMB	DESCRIPTION	DATE	APP
0	CORRECTED FINAL DESIGN SUBMITTAL	09/15/10	WESR
B	FINAL DESIGN SUBMITTAL	09/02/10	WESR
A	MID-POINT DESIGN SUBMITTAL	08/13/10	WESR

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KCB	09/15/10
DRAWN BY:	SUBMITTED BY:
NLL	TETRA TECH
CHECKED BY:	FILE NO.:
KCB	AF1082A-AR100PN

US Army Corps of Engineers
Middle East District


AUSTERE STANDARD DESIGNS - PHASE 5
FY11 BARRACKS - PN74129-CLN04
KANDAHAR AIR BASE, AFGHANISTAN

GROUND FLOOR PLAN

SHEET REFERENCE NUMBER:
AF1082A
A-100

UNLESS OTHERWISE NOTED, ALL DIMENSIONS SHOWN ARE IN MILLIMETERS.

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FIRST FLOOR PLAN
SCALE 1:100

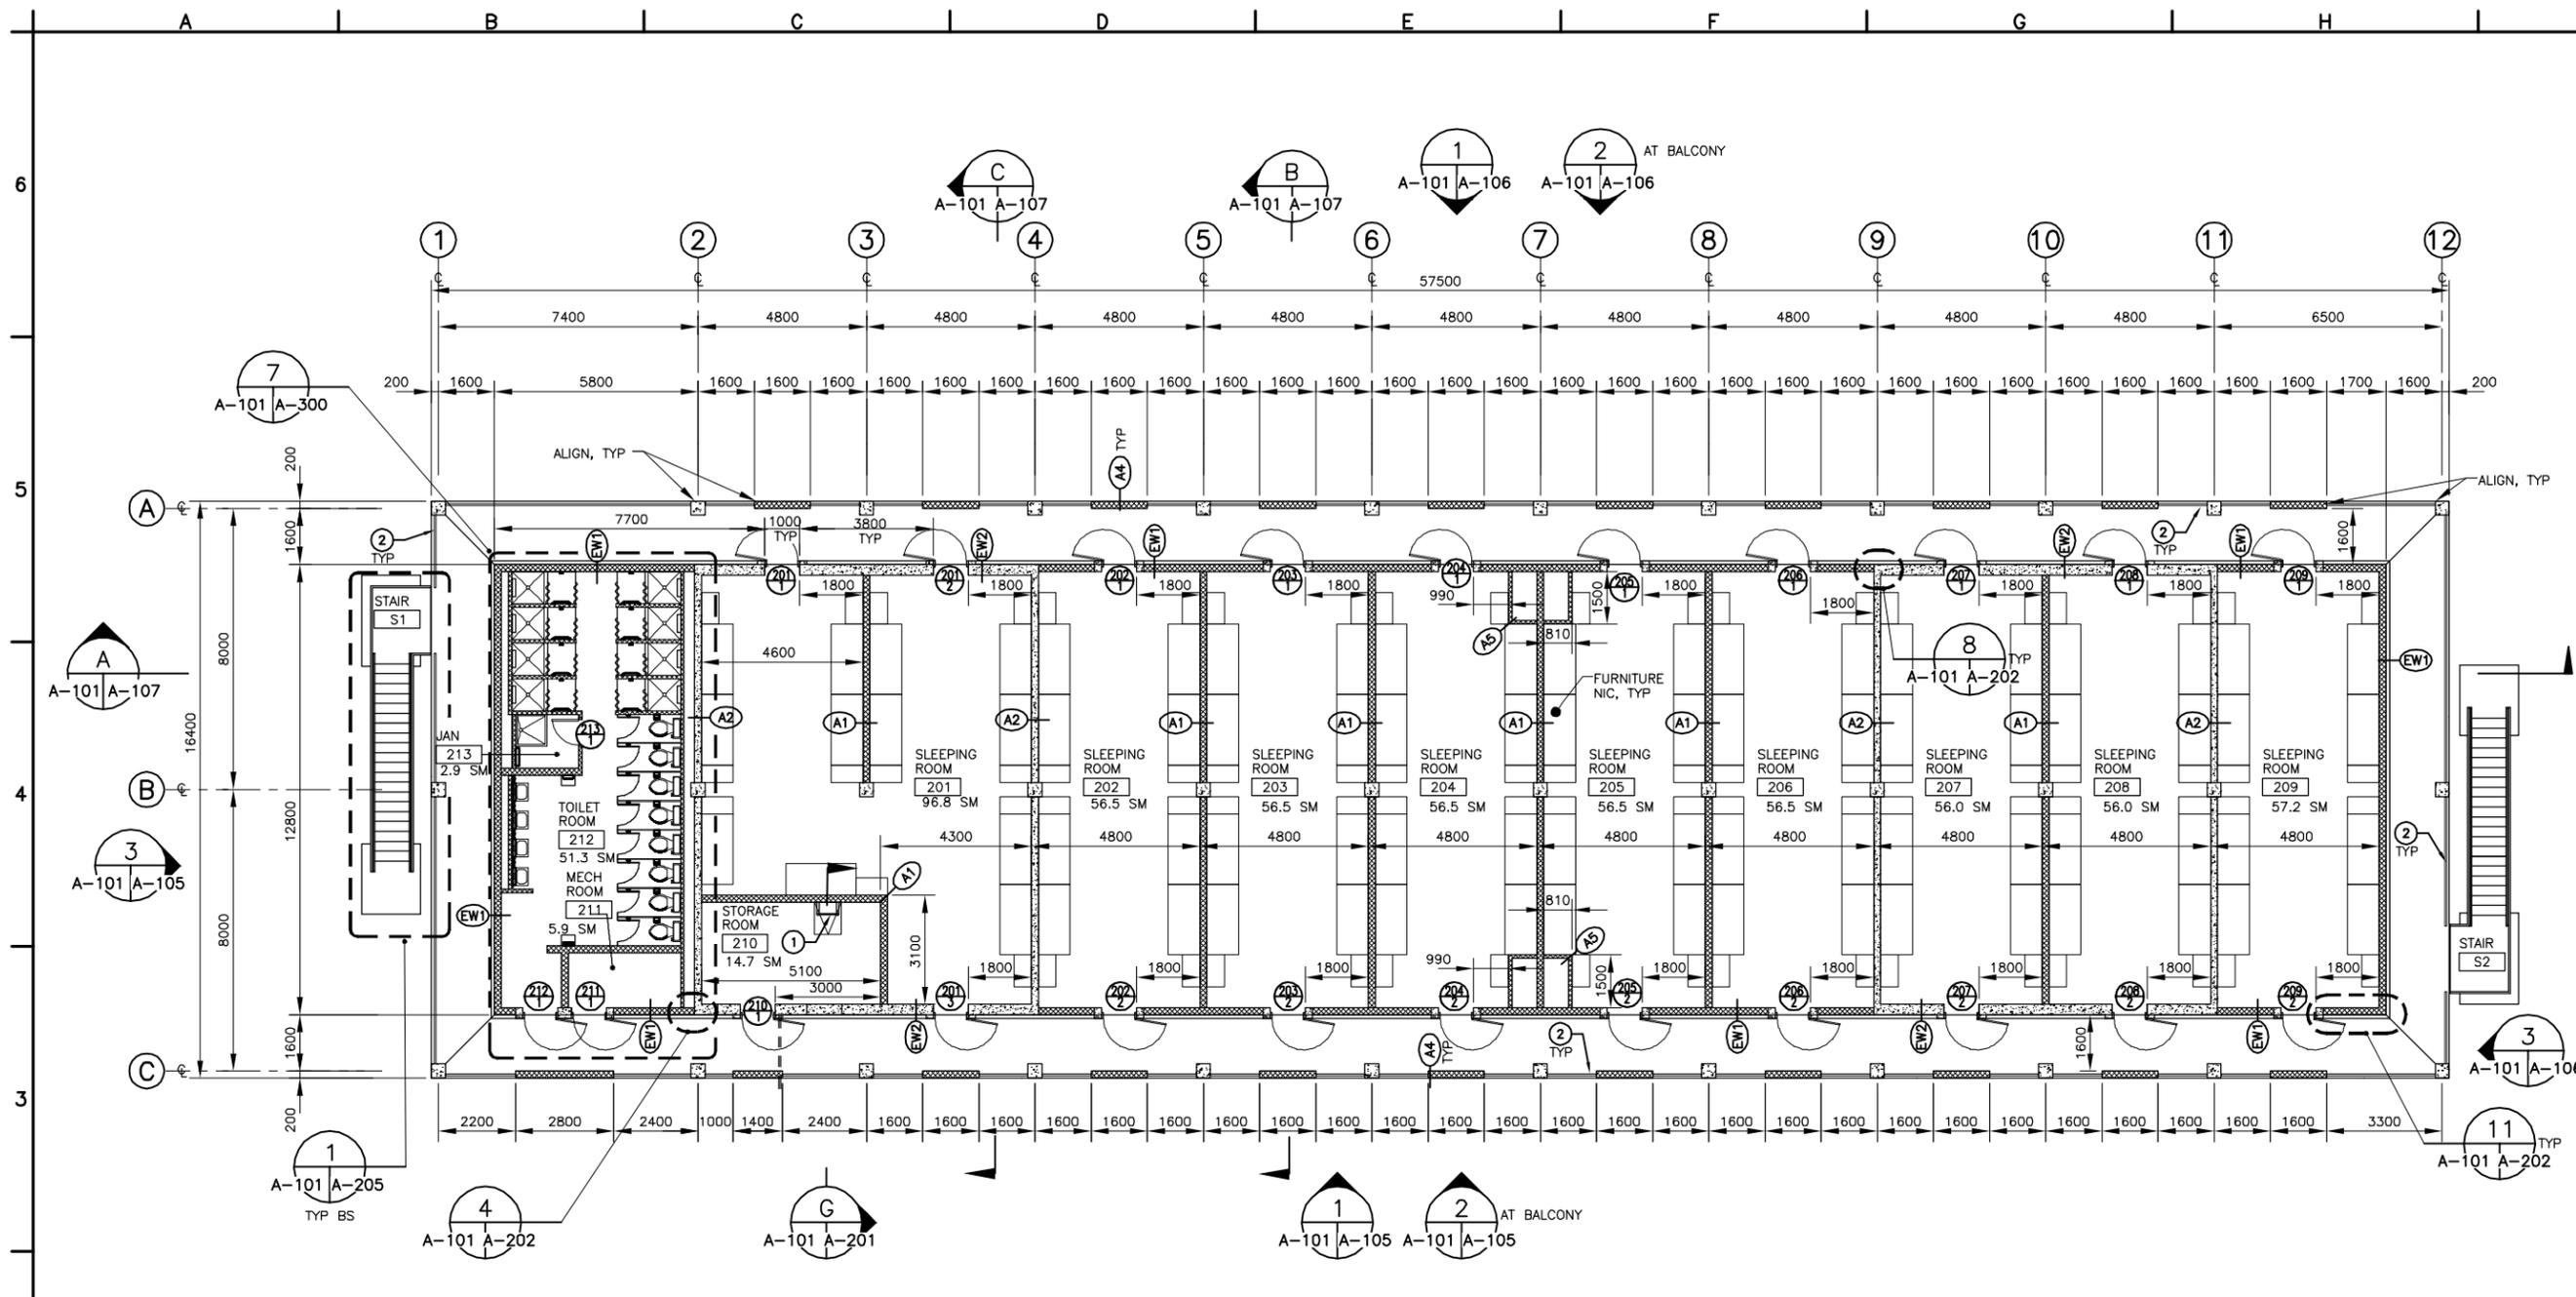

GENERAL NOTES:

1. UNO, ALL MASONRY/ROUGH OPENINGS FOR DOORS ARE 100mm FROM FACE OF MASONRY.
2. REFER TO DRAWING A-202 FOR WALL TYPE AND PARTITION TYPE DETAILS.
3. REFER TO LIFE SAFETY PLANS FOR FIRE RATINGS
4. REFER TO MECH, PLUMB, FP, FA, ELEC, AND TC DWGS FOR PENETRATION LOCATIONS, SEE S/A-203 FOR PIPE PENETRATION DETAIL AND 6/M-201 FOR DUCT PENETRATION DETAIL.

SPECIFIC NOTES:

- ① ROOF ACCESS LADDER. SEE DETAIL 2/A-203.
- ② GUARD RAILINGS. SEE DETAIL 6/A-206.

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CORRECTED
FINAL
DESIGN
SUBMITTAL

SYMB	DESCRIPTION	DATE	APP
D	CORRECTED FINAL DESIGN SUBMITTAL	09/15/10	WESR
B	FINAL DESIGN SUBMITTAL	09/02/10	WESR
A	MID-POINT DESIGN SUBMITTAL	08/13/10	WESR

DESIGNED BY:	DATE:	09/15/10
KCB		
DRAWN BY:	SUBMITTED BY:	TETRA TECH
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KCB		

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TETRA TECH


AUSTERE STANDARD DESIGNS - PHASE 5
FY11 BARRACKS - PN74129-CLN04
KANDAHAR AIR BASE, AFGHANISTAN

FIRST FLOOR PLAN

SHEET
REFERENCE
NUMBER:
AF1082A
A-101

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GROUND FLOOR REFLECTED PLAN
SCALE 1:100

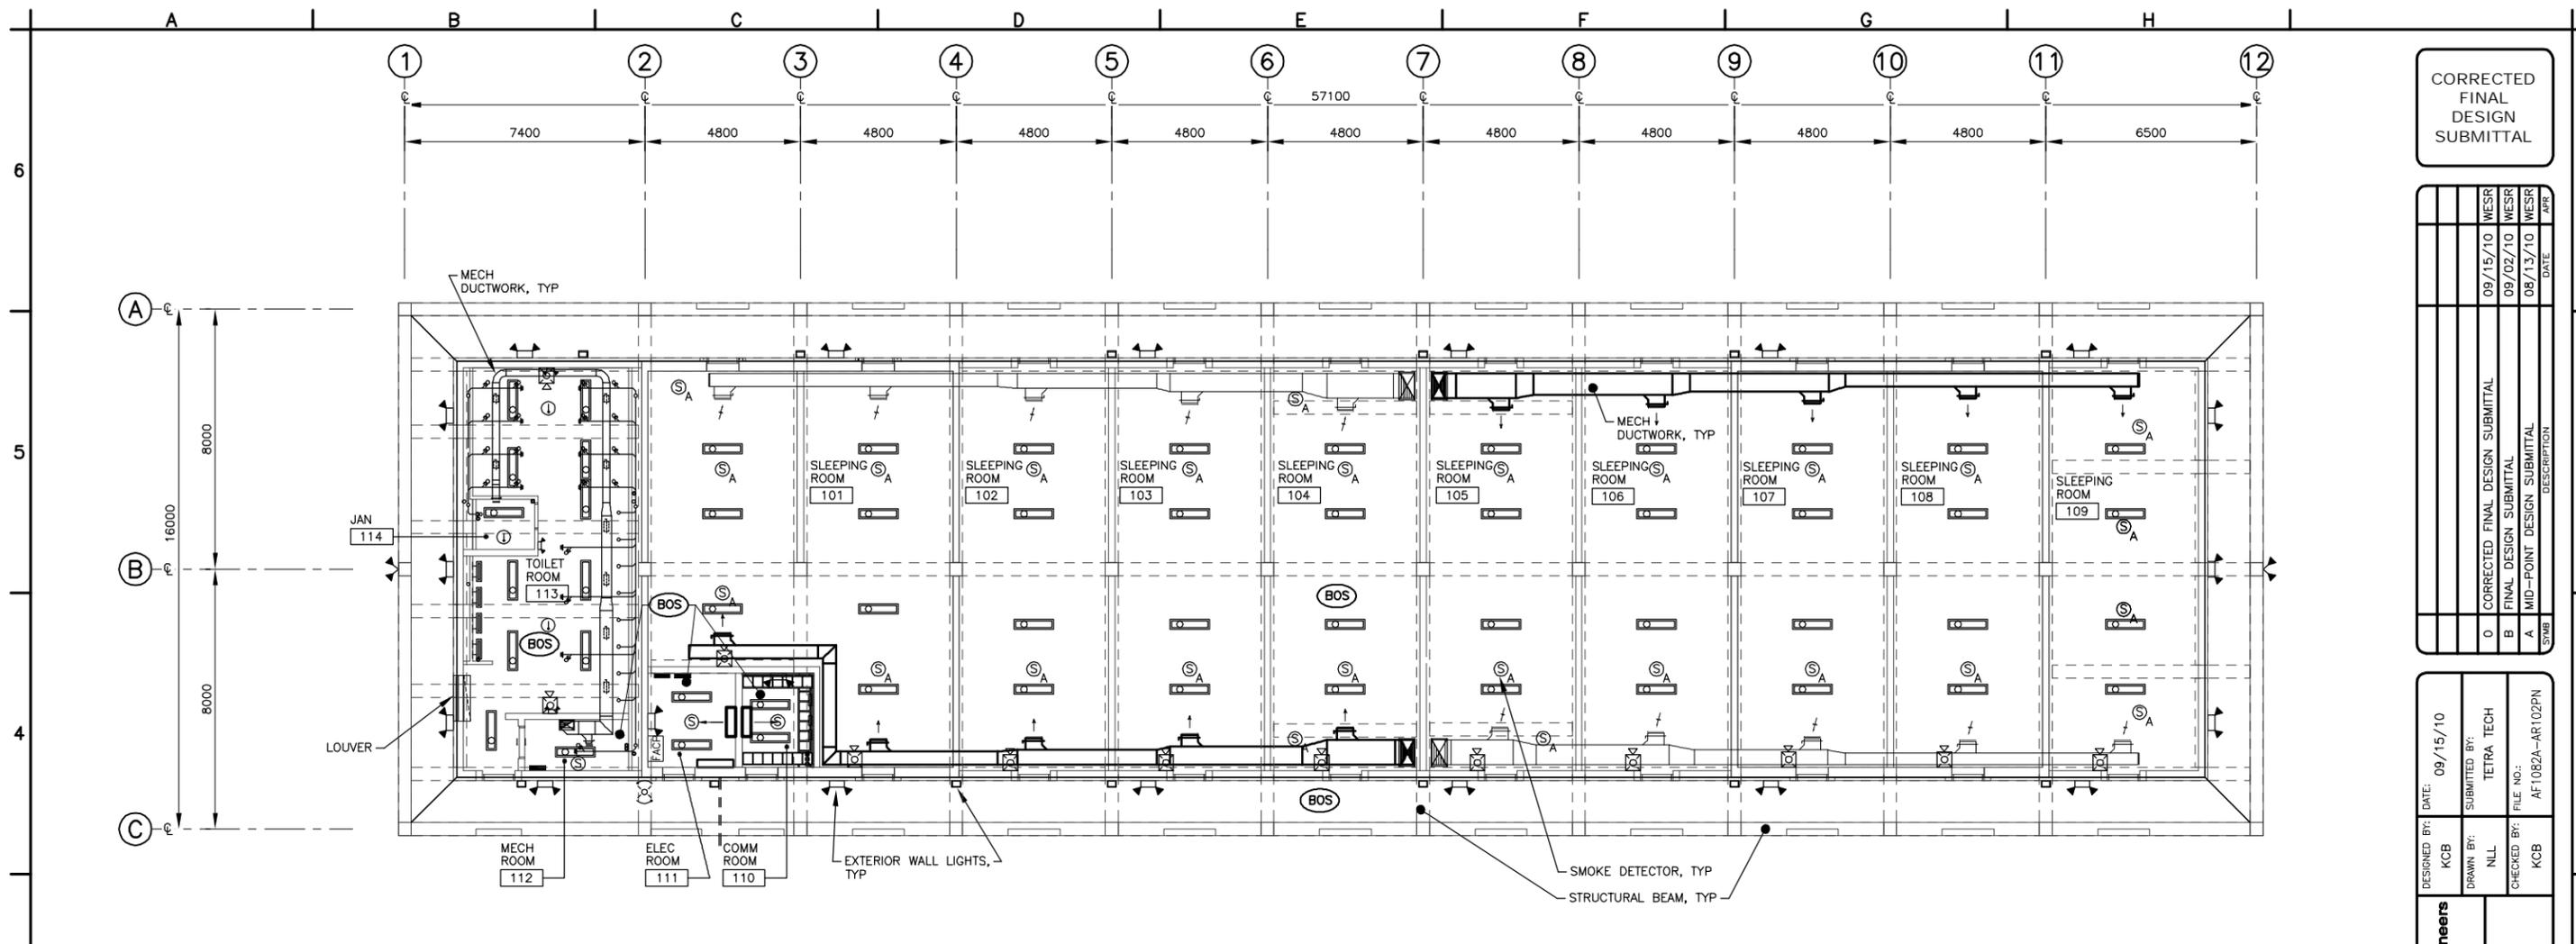

CEILING LEGEND	
	LIGHT FIXTURES, SEE ELEC
	SMOKE ALARMS/DETECTORS, SEE LIFE SAFETY
	EMERGENCY AND EXIT LIGHT FIXTURES, SEE ELEC
	FIRE PROTECTION SPEAKER/STROBE
	EXTERIOR LIGHT FIXTURE, SEE ELEC
	RETURN GRILLE, SEE MECH
	UNIT HEATER, SEE HVAC
	EXPOSED STRUCTURE
	DESIGNATES BOTTOM OF CEILING AFF AT THAT POINT UNO

NOTE:
1. ALL ROOMS ARE EXPOSED CONCRETE CEILING. PAINT ALL EXPOSED SURFACES IN ACCORDANCE WITH SECTION 09 90 00.
2. THIS LAYOUT IS FOR COORDINATION PURPOSES ONLY. REFER TO MECHANICAL, TELECOMMUNICATIONS, STRUCTURAL, LIFE SAFETY, AND ELECTRICAL DRAWINGS FOR ADDITIONAL INFORMATION.

UNLESS OTHERWISE NOTED, ALL DIMENSIONS SHOWN ARE IN MILLIMETERS.

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CORRECTED FINAL DESIGN SUBMITTAL

SYMB	DESCRIPTION	DATE	APP
O	CORRECTED FINAL DESIGN SUBMITTAL	09/15/10	WESR
B	FINAL DESIGN SUBMITTAL	09/02/10	WESR
A	MID-POINT DESIGN SUBMITTAL	08/13/10	WESR

DESIGNED BY:	KCB	DATE:	09/15/10
DRAWN BY:	NULL	SUBMITTED BY:	TETRA TECH
CHECKED BY:	KCB	FILE NO.:	AF1082A-AR102PN

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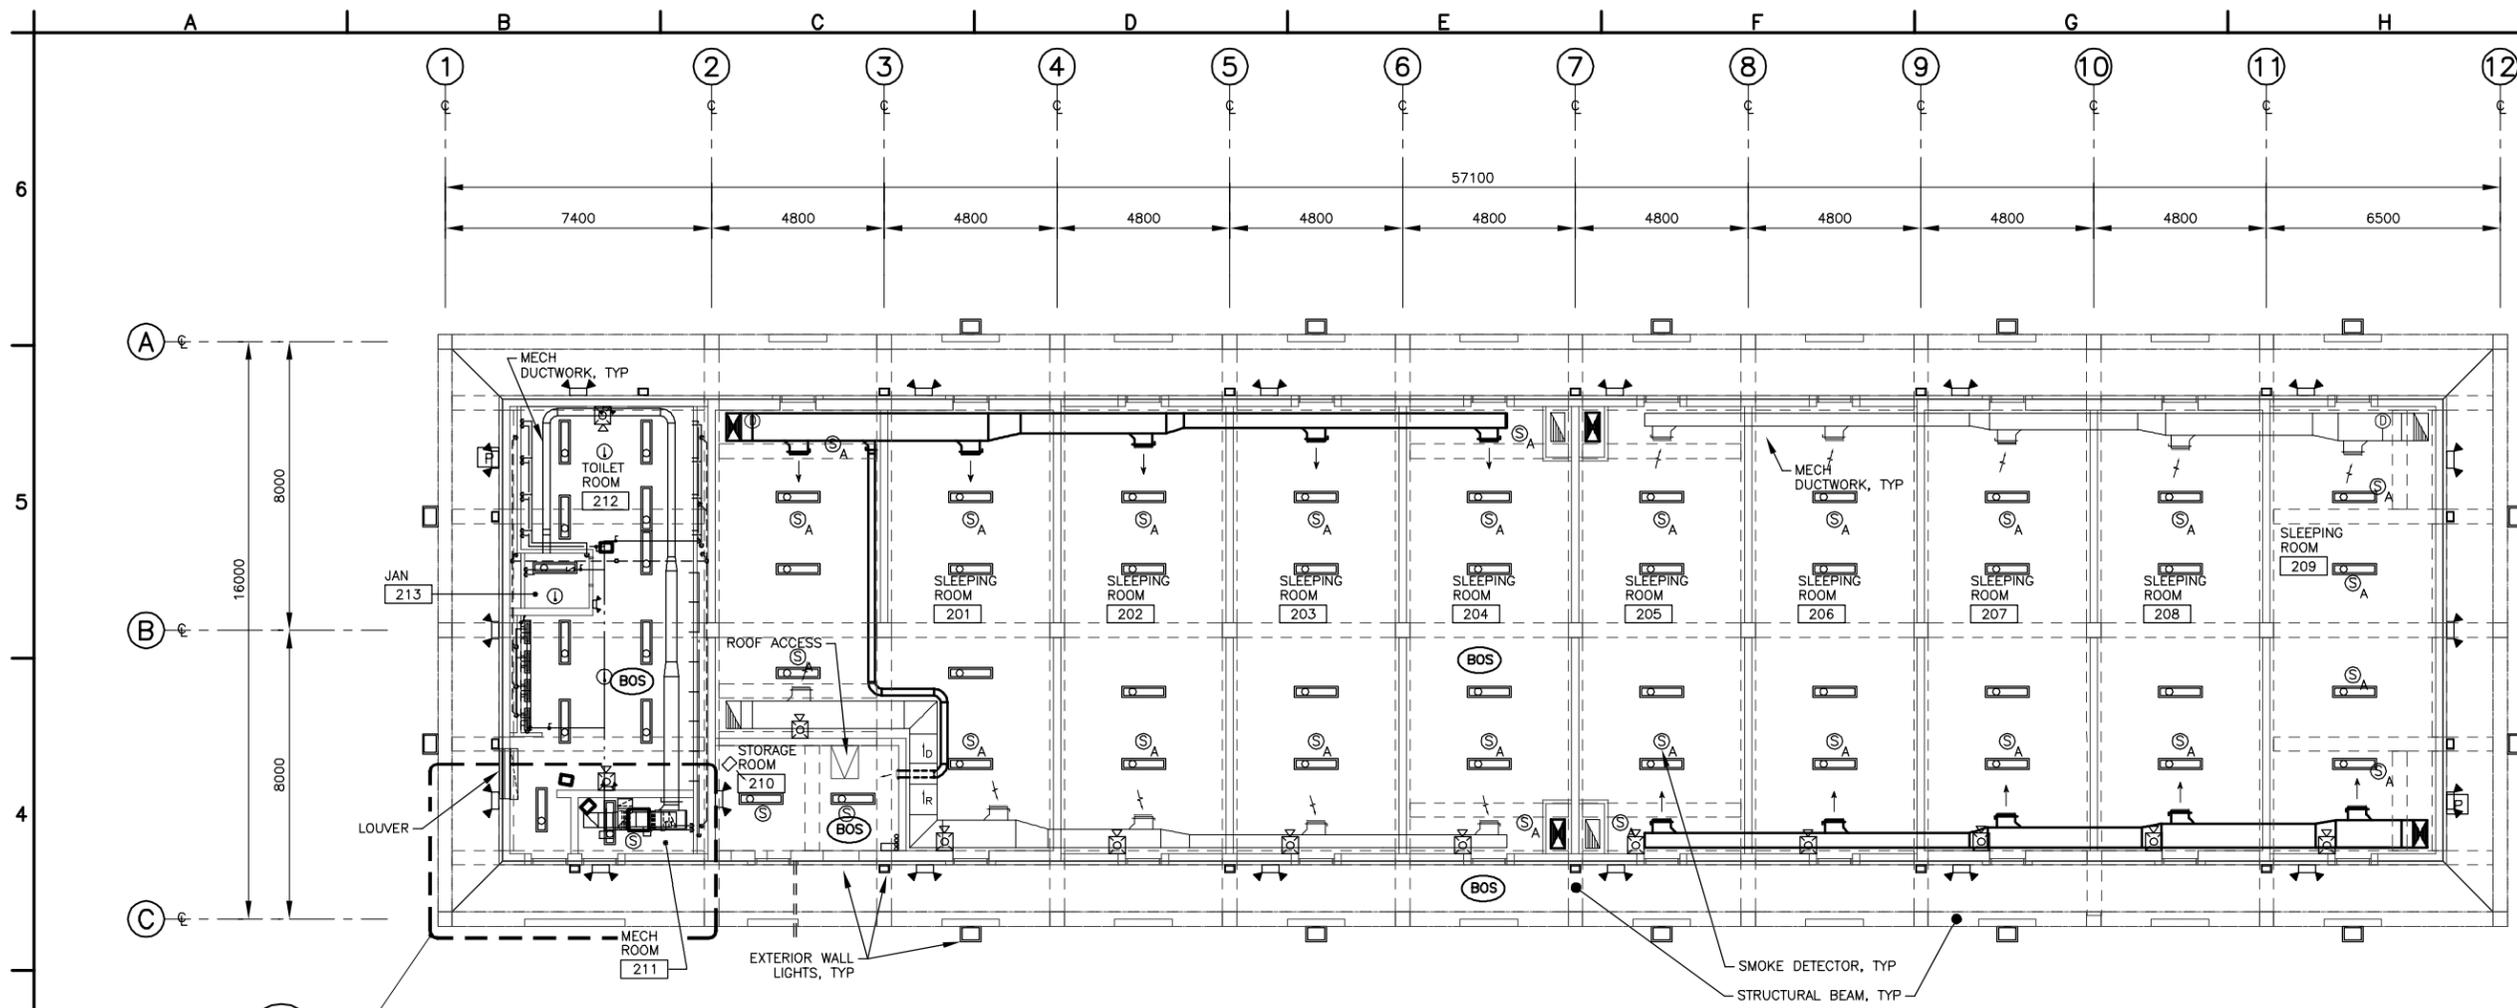
TETRA TECH

AUSTER STANDARD DESIGNS-PHASE 5
FY11 BARRACKS - PN74129-CLN04
KANDAHAR AIR BASE, AFGHANISTAN


GROUND FLOOR REFLECTED CEILING PLAN

SHEET REFERENCE NUMBER:
AF1082A
A-102

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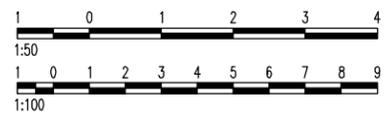
FIRST FLOOR REFLECTED PLAN
SCALE 1:100



ENLARGED MECHANICAL REFLECTED PLAN
SCALE 1:50

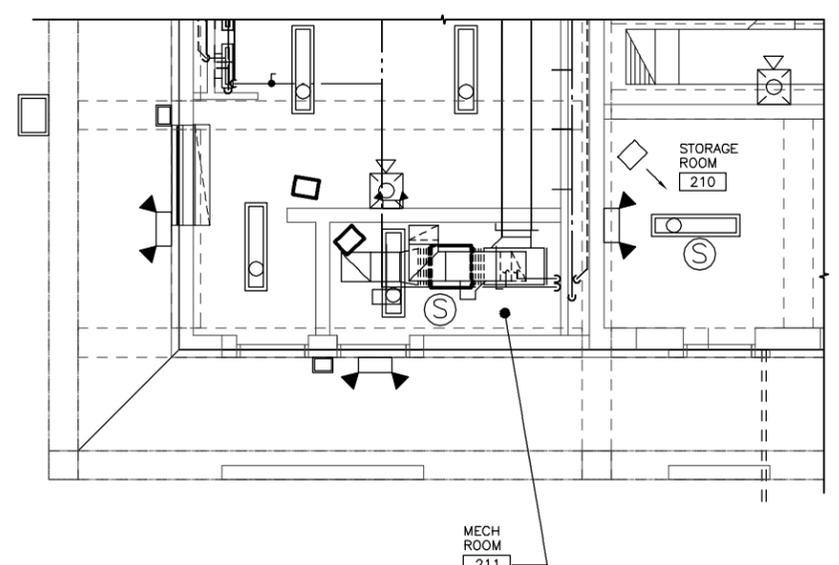CEILING LEGEND	
	LIGHT FIXTURES, SEE ELEC
	SMOKE ALARMS/DETECTORS, SEE LIFE SAFETY
	EMERGENCY AND EXIT LIGHT FIXTURES, SEE ELEC
	FIRE PROTECTION SPEAKER/STROBE
	EXTERIOR LIGHT FIXTURE, SEE ELEC
	RETURN GRILLE, SEE MECH
	UNIT HEATER, SEE HVAC
	EXPOSED STRUCTURE
	DESIGNATES BOTTOM OF CEILING OFF AT THAT POINT UNO

NOTE:
1. ALL ROOMS ARE EXPOSED CONCRETE CEILING. PAINT ALL EXPOSED SURFACES IN ACCORDANCE WITH SECTION 09 90 00.
2. THIS LAYOUT IS FOR COORDINATION PURPOSES ONLY. REFER TO MECHANICAL, TELECOMMUNICATIONS, STRUCTURAL, LIFE SAFETY, AND ELECTRICAL DRAWINGS FOR ADDITIONAL INFORMATION.



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CORRECTED FINAL DESIGN SUBMITTAL

SYMB	DESCRIPTION	DATE	APP
0	CORRECTED FINAL DESIGN SUBMITTAL	09/15/10	WESR
B	FINAL DESIGN SUBMITTAL	09/02/10	WESR
A	MID-POINT DESIGN SUBMITTAL	08/13/10	WESR

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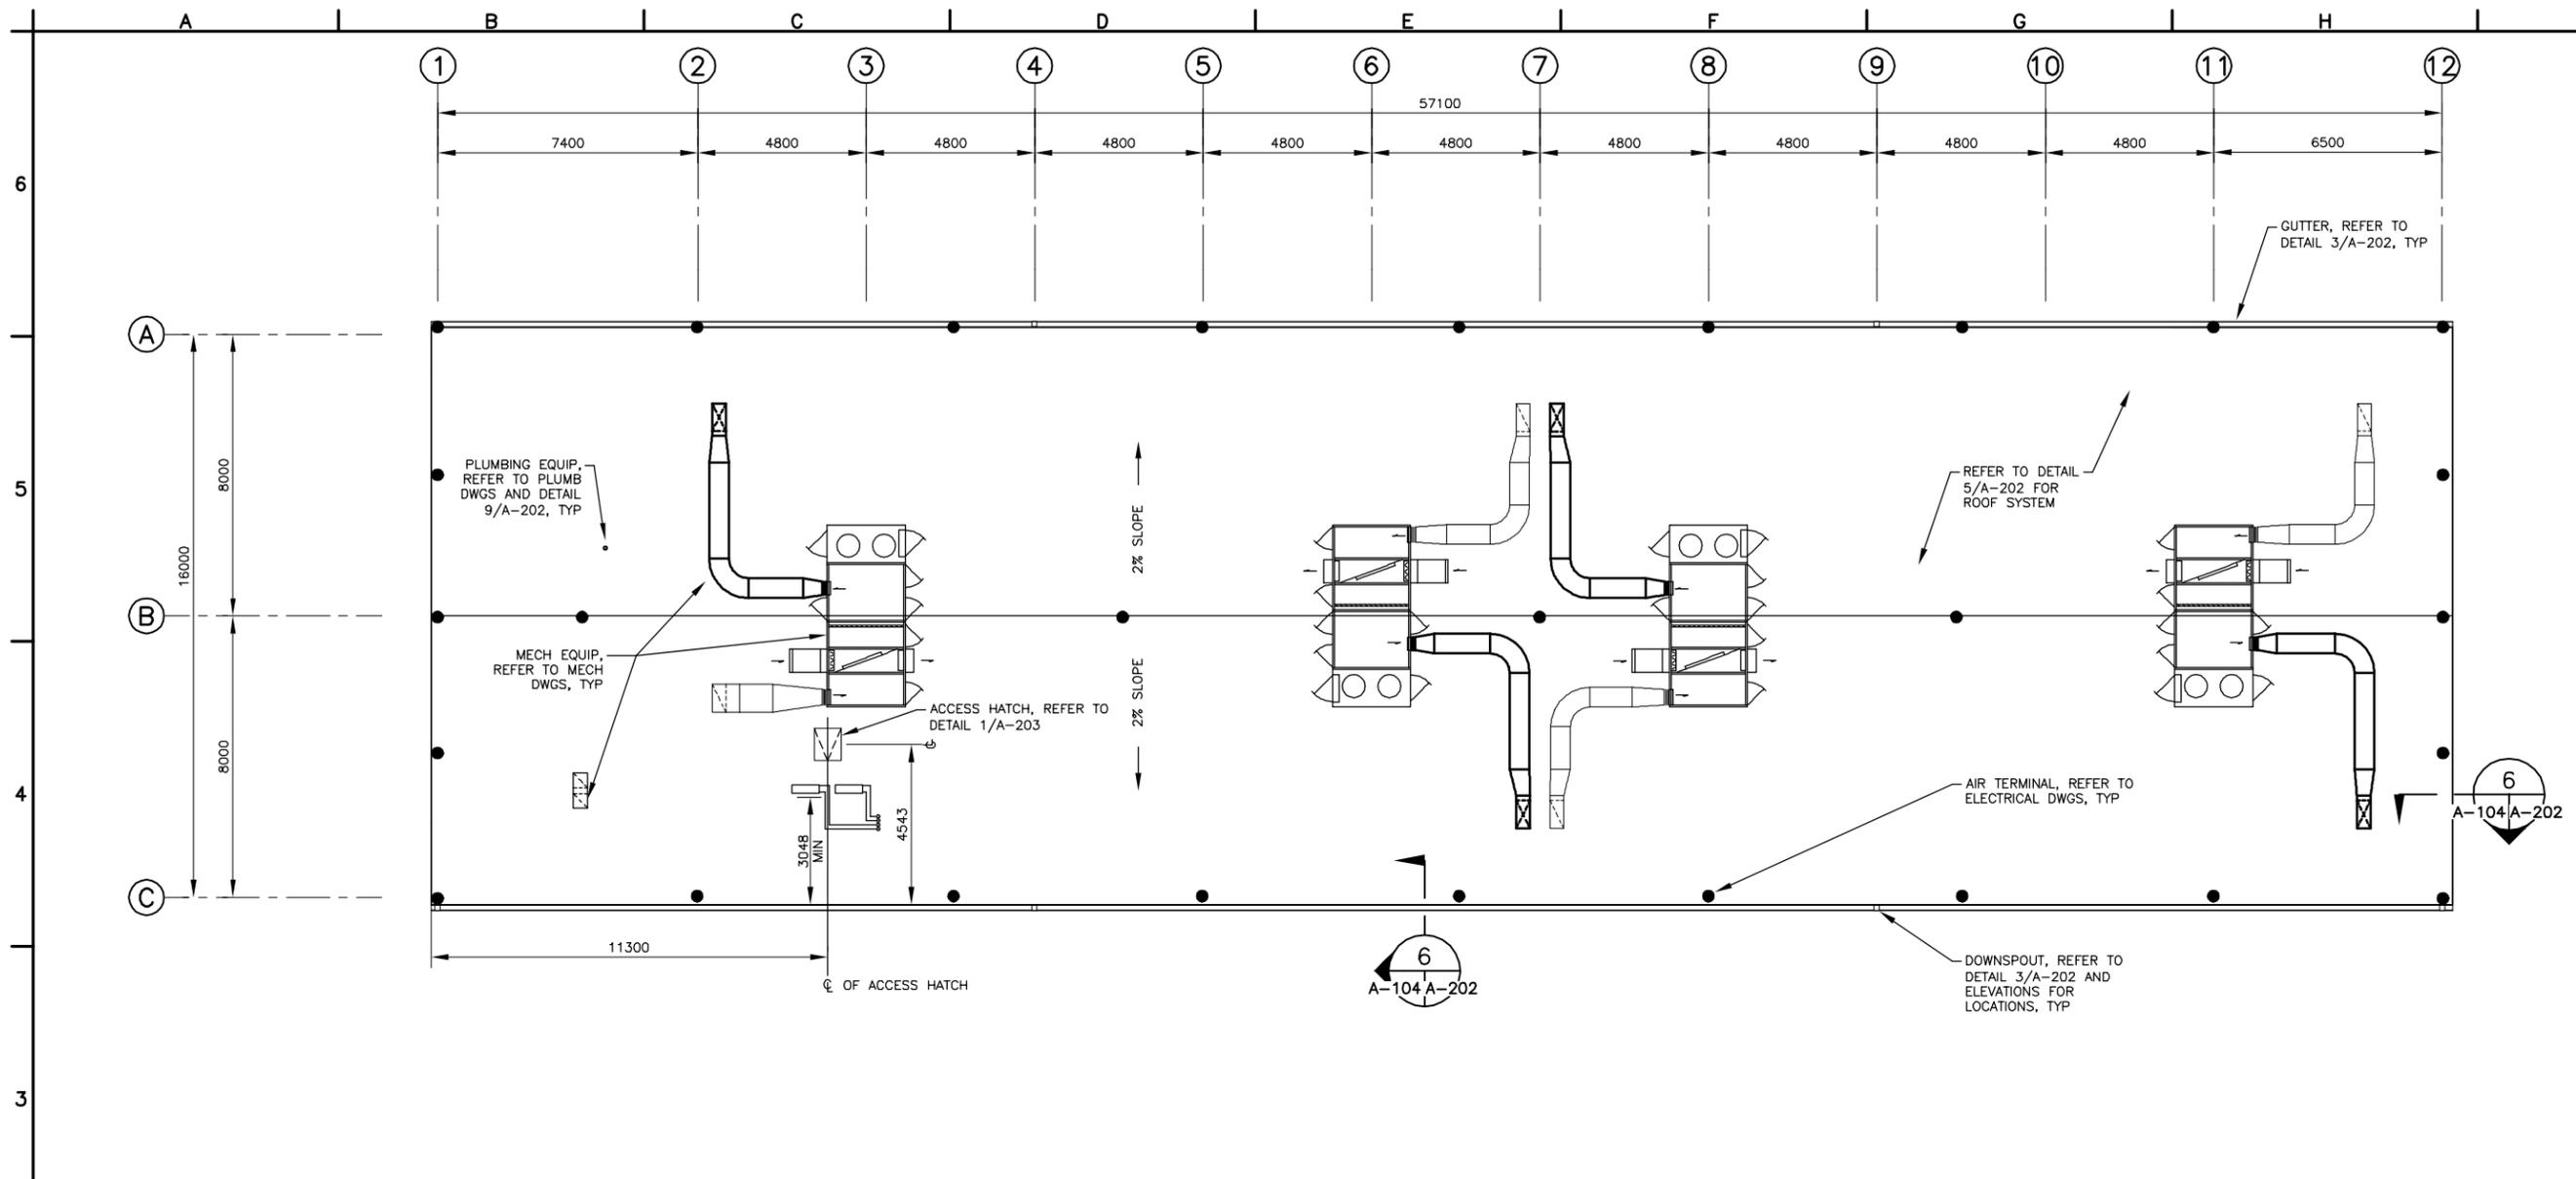
AUSTERE STANDARD DESIGNS-PHASE 5
FY11 BARRACKS - PN74129-CLN04
KANDAHAR AIR BASE, AFGHANISTAN

FIRST FLOOR REFLECTED CEILING PLAN

SHEET REFERENCE NUMBER:
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ROOF PLAN
SCALE 1:100

GENERAL NOTES:

- REFER TO DETAILS 3 AND 4 ON DRAWING A-203 FOR ROOF PENETRATION AND CURB FLASHING DETAILS.



THESE DRAWINGS ARE "NOT APPROVED FOR CONSTRUCTION" SINCE THESE ARE BASED UPON ASSUMED CONDITIONS. THE CONTRACTOR SHALL NOT PROCEED WITH CONSTRUCTION UNTIL THE ASSUMED CONDITIONS ARE VALIDATED AND APPROVAL IS RECEIVED FROM THE CONTRACTING OFFICER.



CORRECTED
FINAL
DESIGN
SUBMITTAL

SYMB	DESCRIPTION	DATE	PREP
0	CORRECTED FINAL DESIGN SUBMITTAL	09/15/10	WESR
B	FINAL DESIGN SUBMITTAL	09/02/10	WESR
A	MID-POINT DESIGN SUBMITTAL	08/13/10	WESR

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CHECKED BY:	KCB	FILE NO.:	AF1082A-AR104PN

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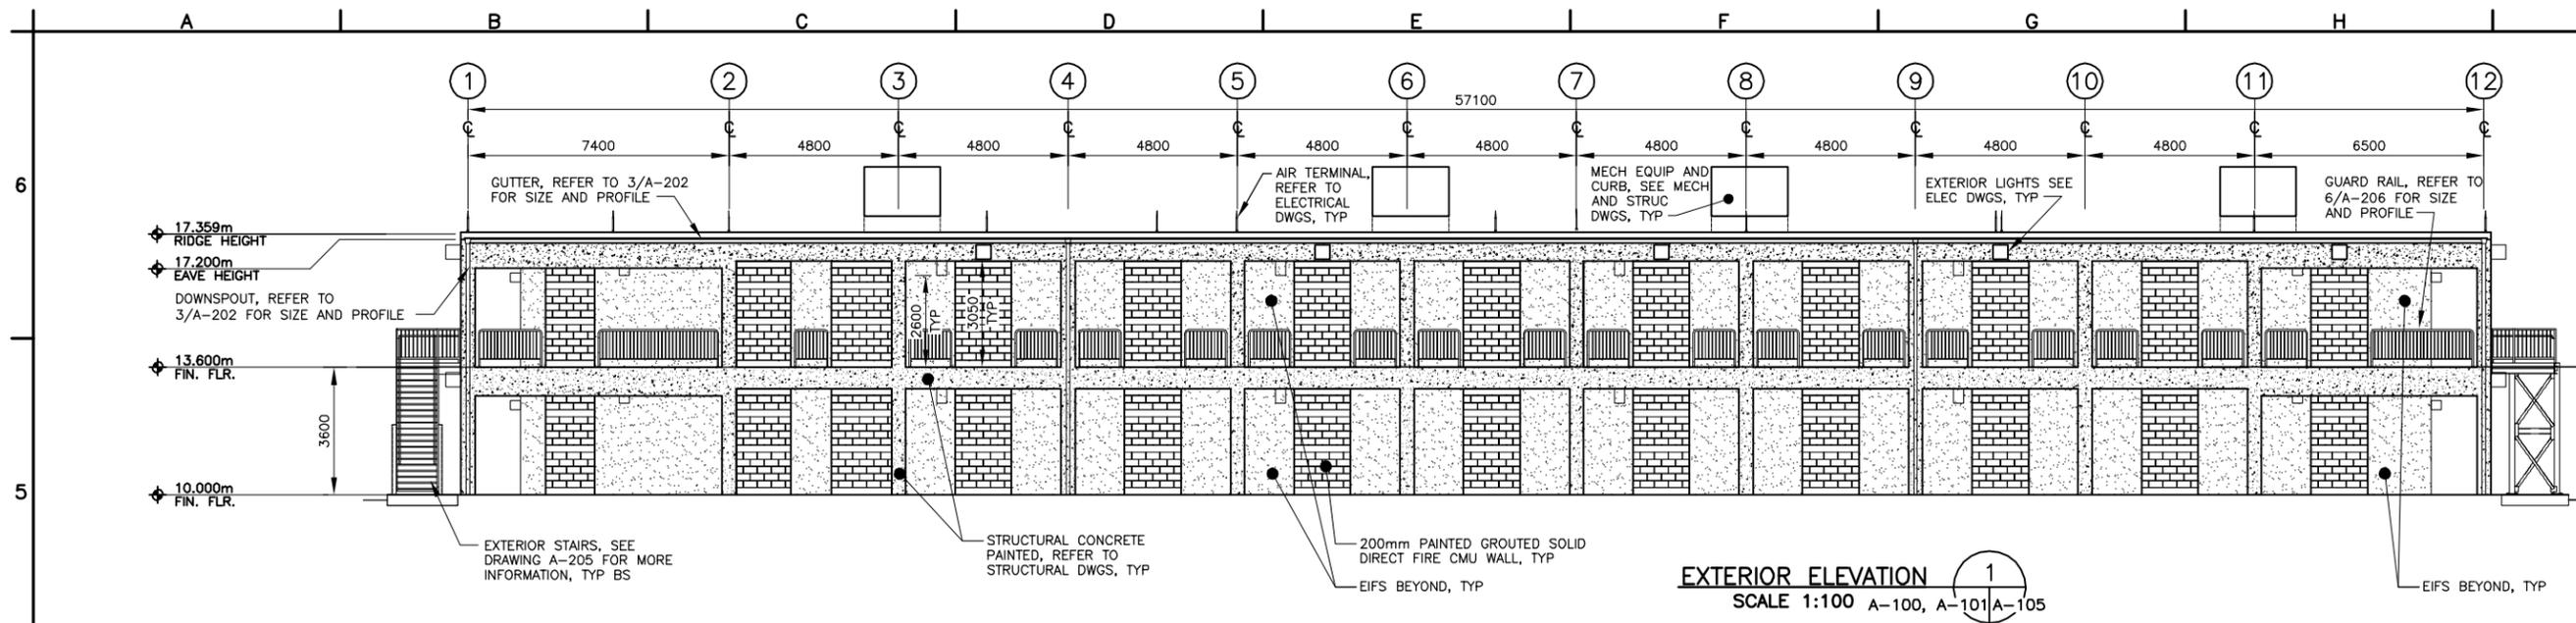
AUSTERE STANDARD DESIGNS—PHASE 5
FY11 BARRACKS — PN74129—CLN04
KANDAHAR AIR BASE, AFGHANISTAN

ROOF PLAN


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A-104

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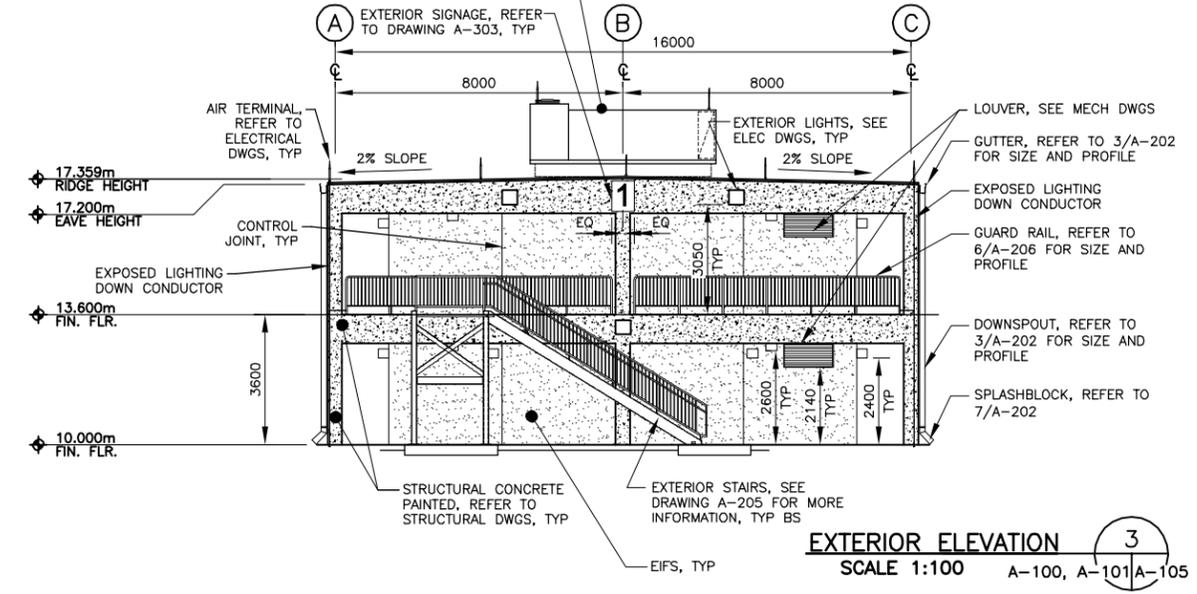
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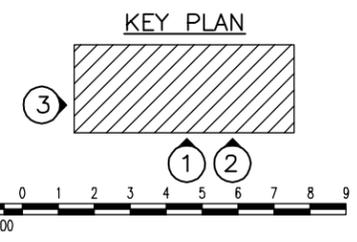
EXTERIOR ELEVATION 1
SCALE 1:100 A-100, A-101 | A-105



EXTERIOR ELEVATION 2
SCALE 1:100 A-100, A-101 | A-105

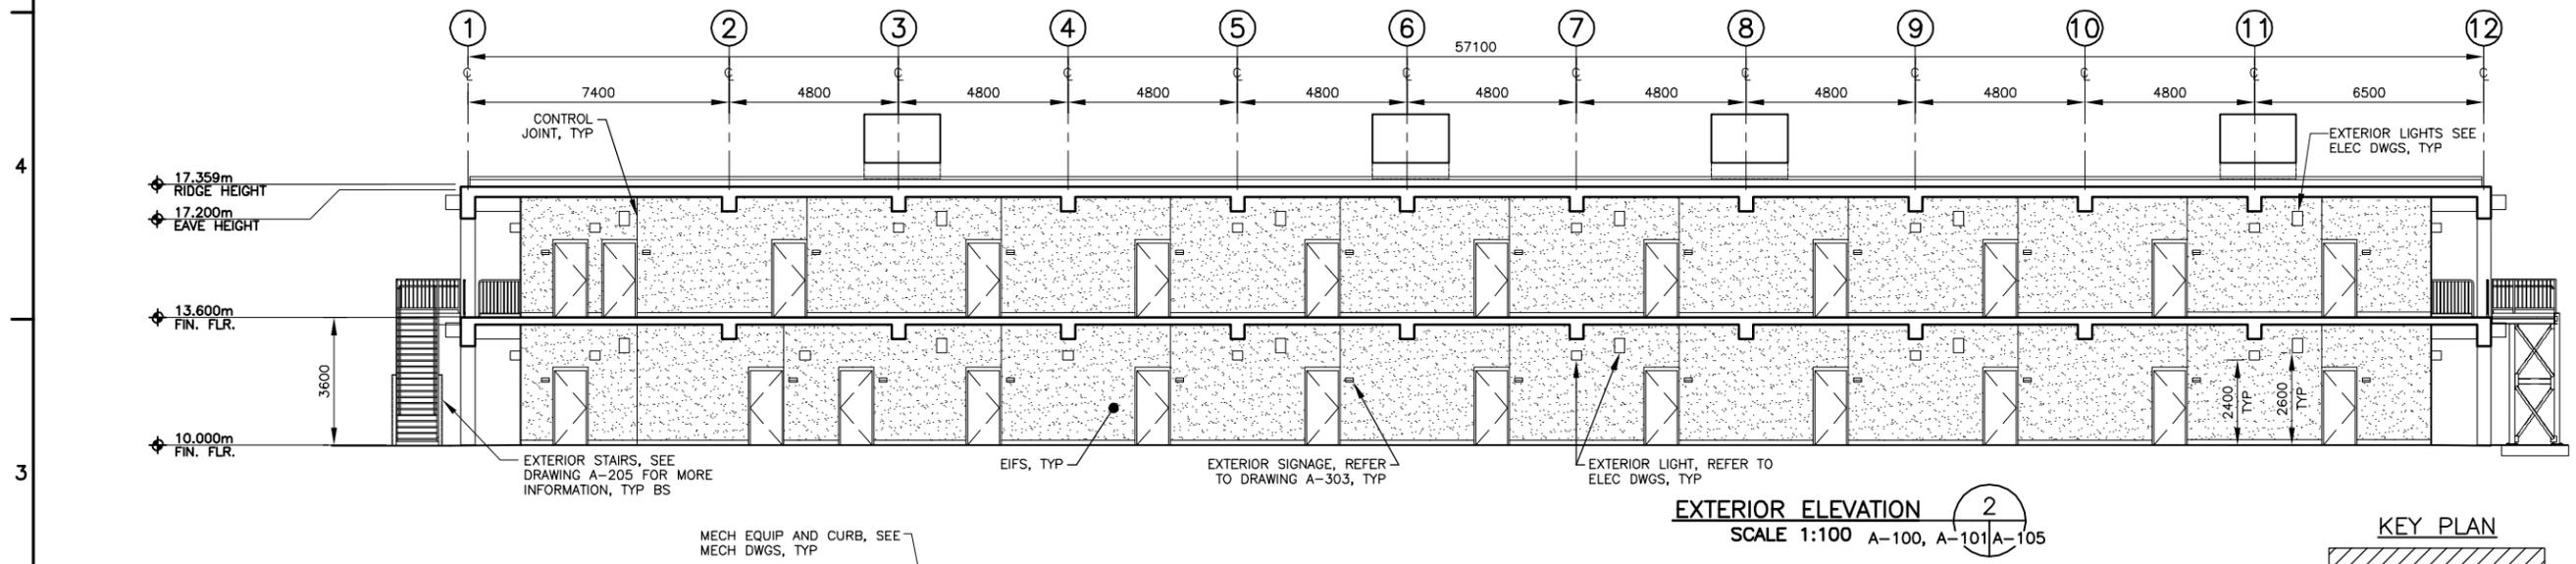

EXTERIOR ELEVATION 3
SCALE 1:100 A-100, A-101 | A-105



- GENERAL NOTES:**
1. PROVIDE ADDITIONAL EIFS CONTROL JOINTS PER MANUFACTURER'S RECOMMENDATIONS.



CORRECTED FINAL DESIGN SUBMITTAL

NO.	DESCRIPTION	DATE	BY
0	CORRECTED FINAL DESIGN SUBMITTAL	09/15/10	WESR
B	FINAL DESIGN SUBMITTAL	09/02/10	WESR
A	MID-POINT DESIGN SUBMITTAL	08/13/10	WESR

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DRAWN BY:	NULL	SUBMITTED BY:	TETRA TECH
CHECKED BY:	KCB	FILE NO.:	AF1082A-AR105EL

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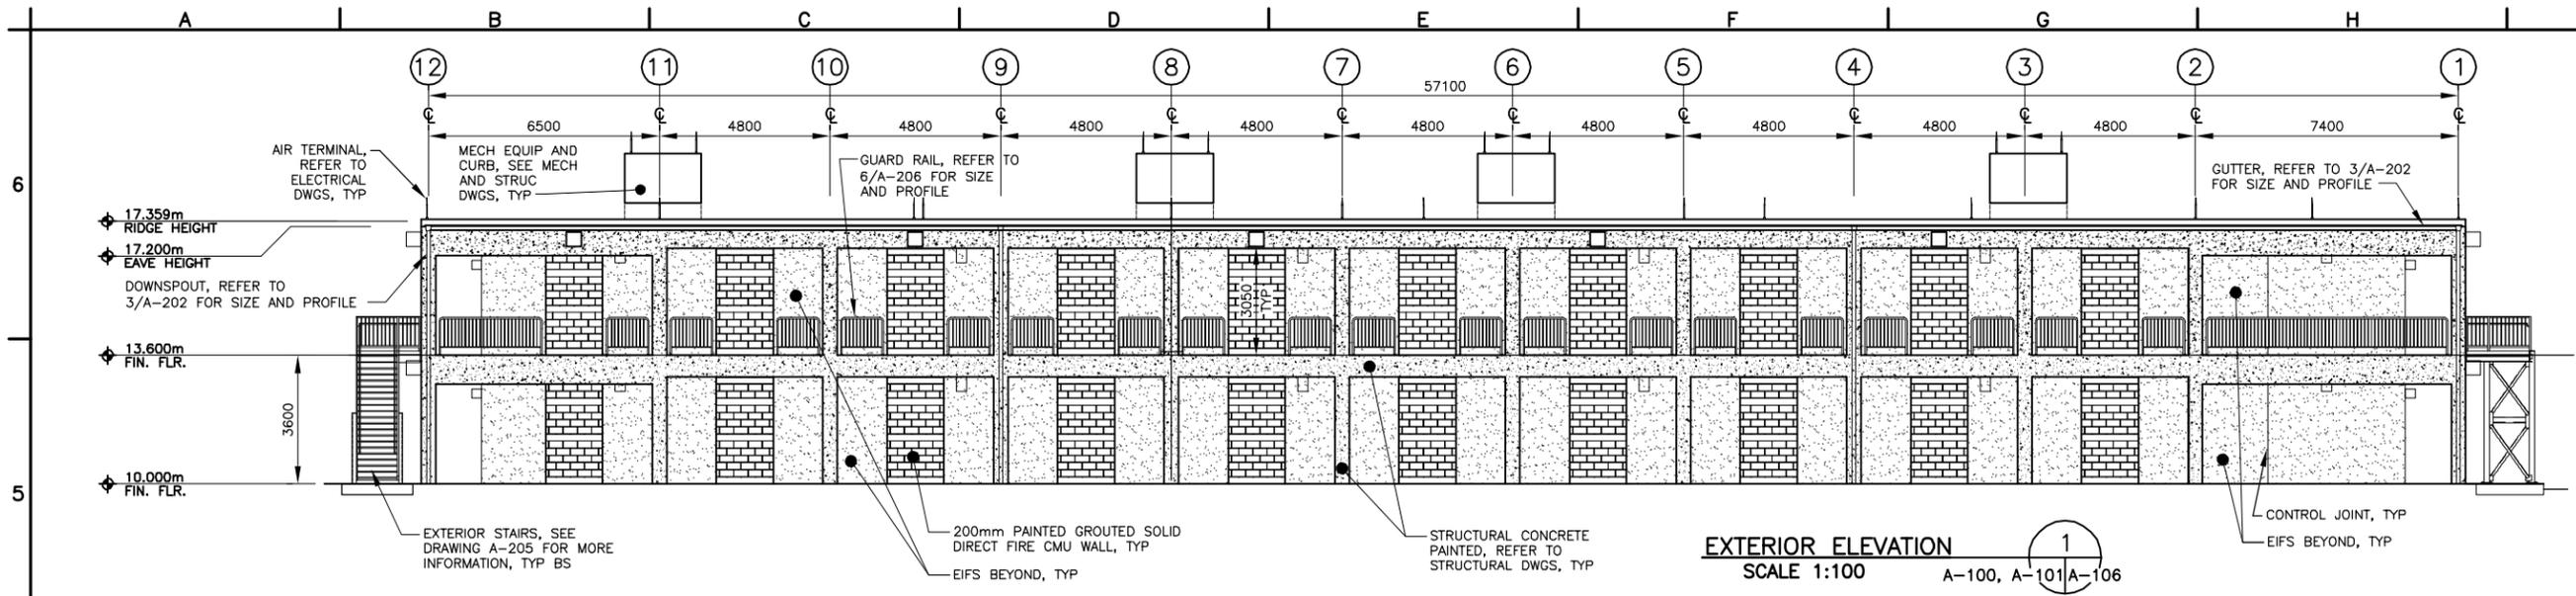
AUSTERE STANDARD DESIGNS - PHASE 5
FY11 BARRACKS - PN74129-CLN04
KANDAHAR AIR BASE, AFGHANISTAN

EXTERIOR ELEVATIONS
SHEET 1 OF 2


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A-105**

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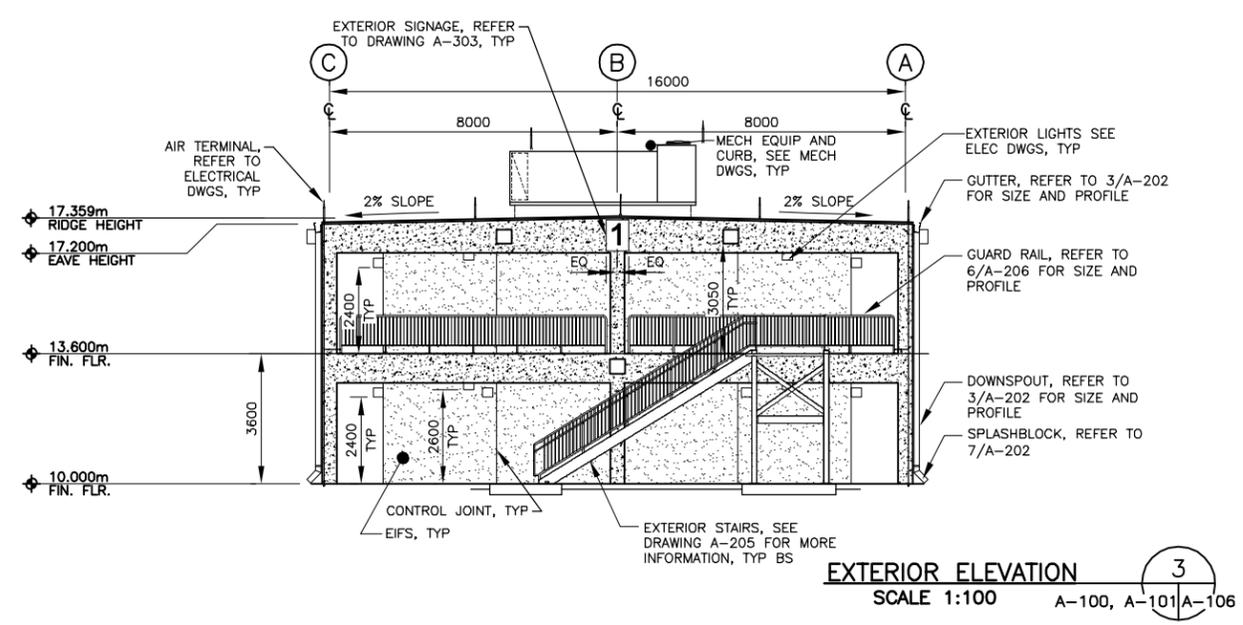
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EXTERIOR ELEVATION 1
SCALE 1:100 A-100, A-101, A-106




EXTERIOR ELEVATION 2
SCALE 1:100 A-100, A-101, A-106

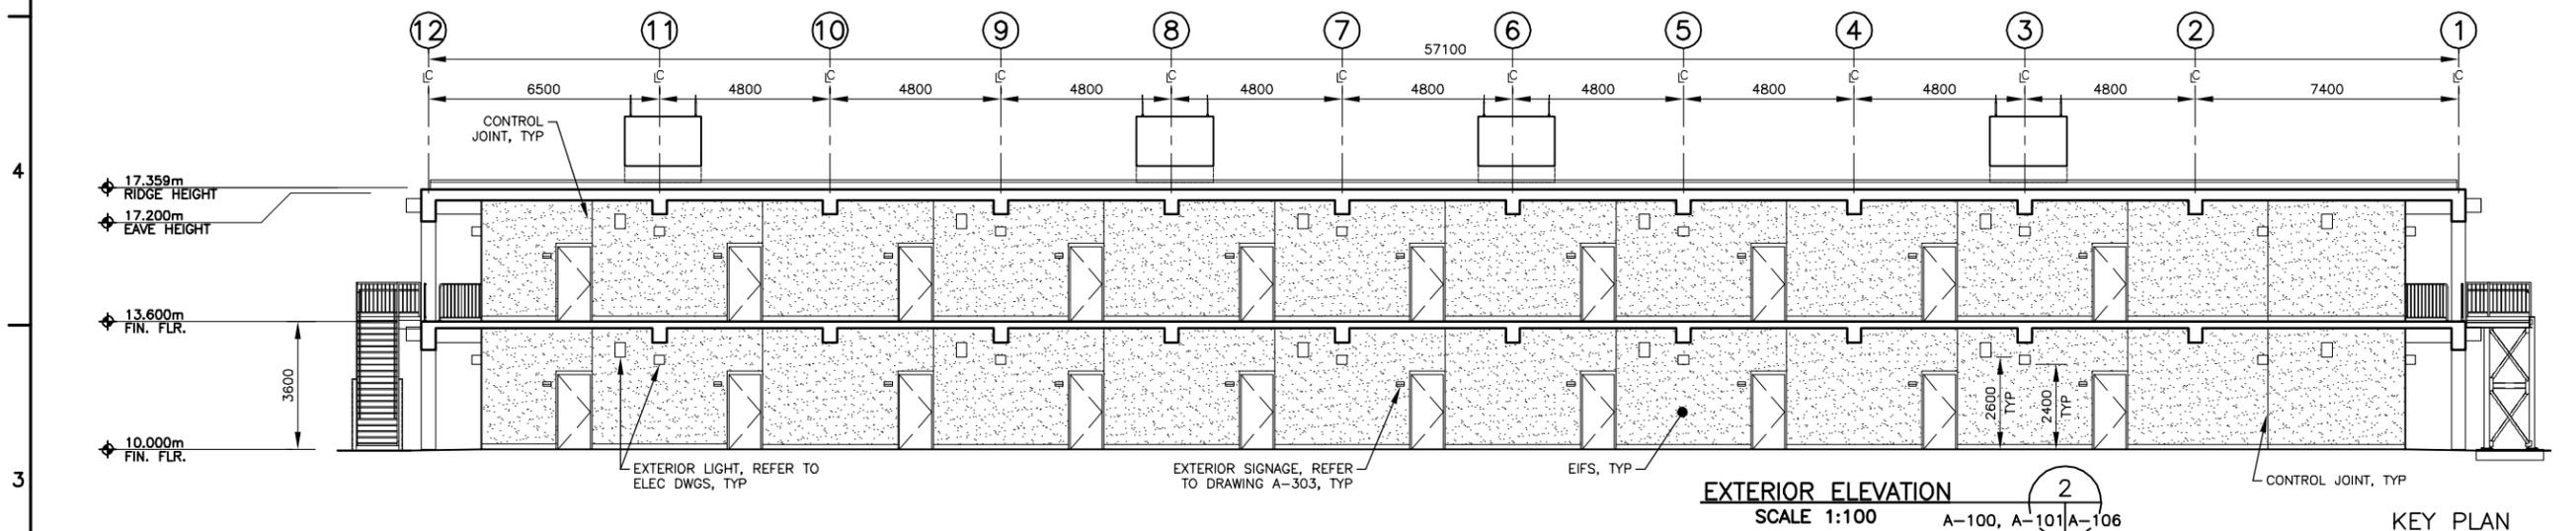

EXTERIOR ELEVATION 3
SCALE 1:100 A-100, A-101, A-106

KEY PLAN

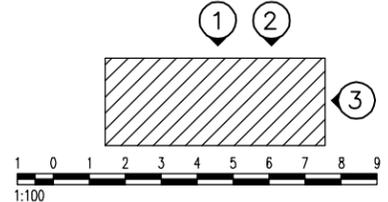

- GENERAL NOTES:**
1. PROVIDE ADDITIONAL EIFS CONTROL JOINTS PER MANUFACTURER'S RECOMMENDATIONS.

UNLESS OTHERWISE NOTED, ALL DIMENSIONS SHOWN ARE IN MILLIMETERS.

CORRECTED FINAL DESIGN SUBMITTAL

NO.	DESCRIPTION	DATE	BY
0	CORRECTED FINAL DESIGN SUBMITTAL	09/15/10	WESR
B	FINAL DESIGN SUBMITTAL	09/02/10	WESR
A	MID-POINT DESIGN SUBMITTAL	08/13/10	WESR

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CHECKED BY:	KCB	FILE NO.:	AF1082A-AR106EL

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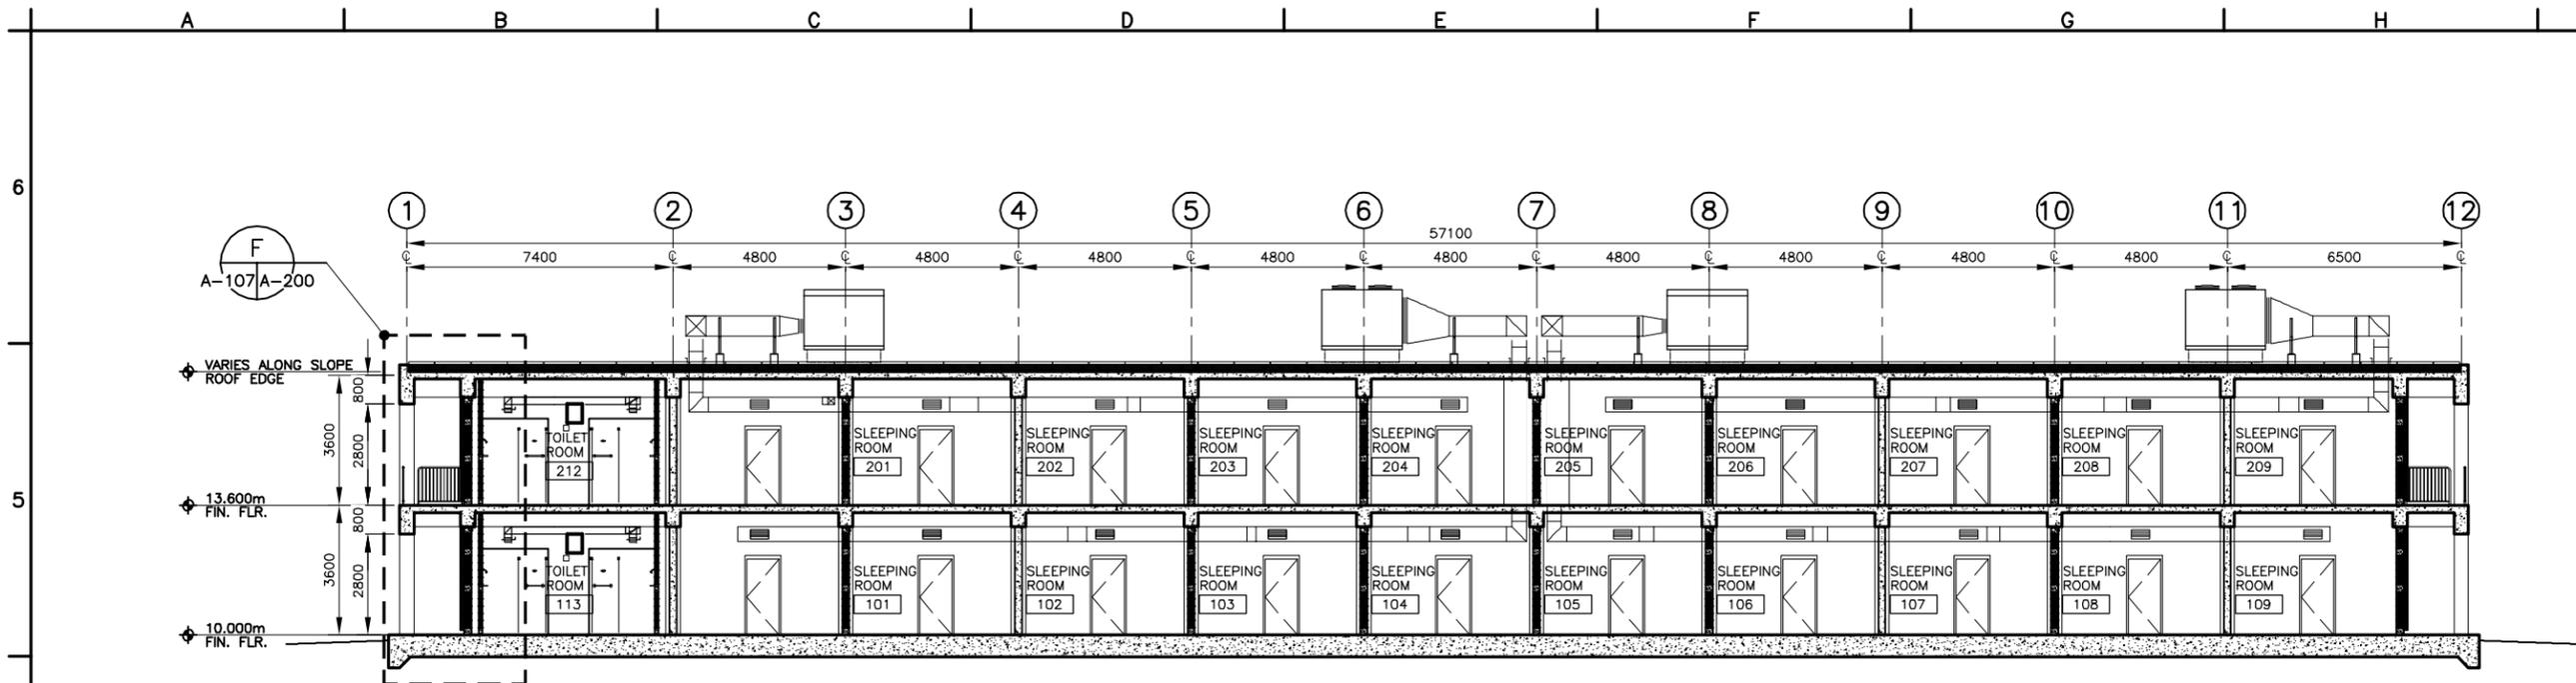


AUSTERE STANDARD DESIGNS - PHASE 5
FY11 BARRACKS - PN74129-CLN04
KANDAHAR AIR BASE, AFGHANISTAN


EXTERIOR ELEVATIONS
SHEET 2 OF 2

SHEET REFERENCE NUMBER:
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A-106**


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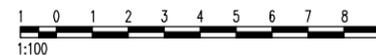
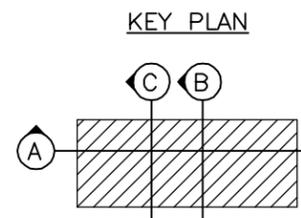
BUILDING SECTION
SCALE 1:100 A-100, A-101 | A-107



BUILDING SECTION
SCALE 1:100 A-100, A-101 | A-107

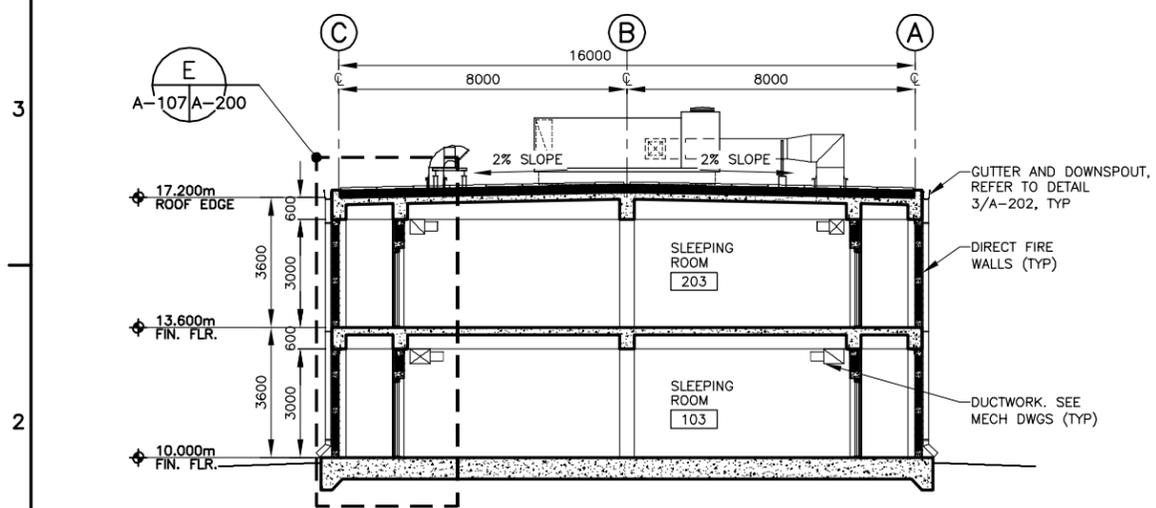

BUILDING SECTION
SCALE 1:100 A-100, A-101 | A-107

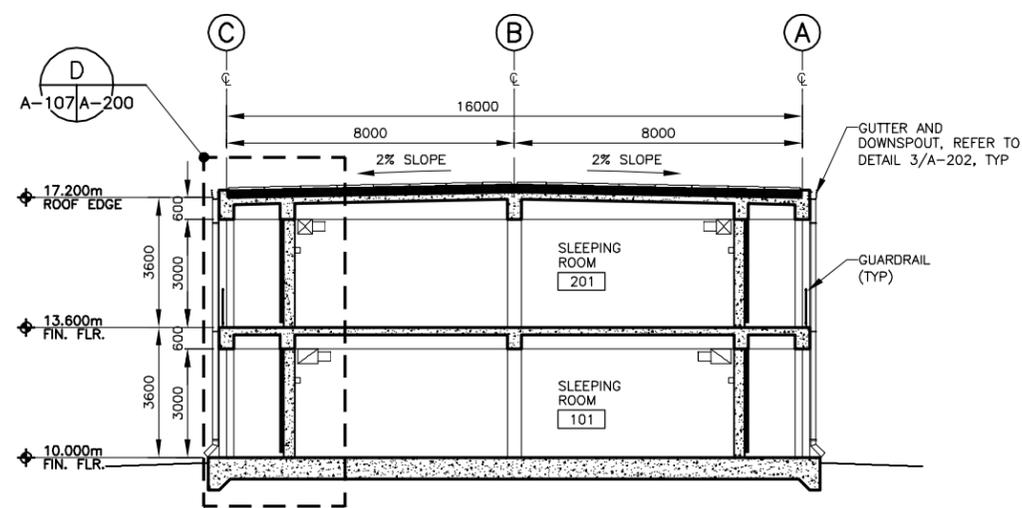

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SUBMITTAL

SYMB	DESCRIPTION	DATE	APP
D	CORRECTED FINAL DESIGN SUBMITTAL	09/15/10	WESR
B	FINAL DESIGN SUBMITTAL	09/02/10	WESR
A	MID-POINT DESIGN SUBMITTAL	08/13/10	WESR

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DRAWN BY:	NULL	SUBMITTED BY:	TETRA TECH
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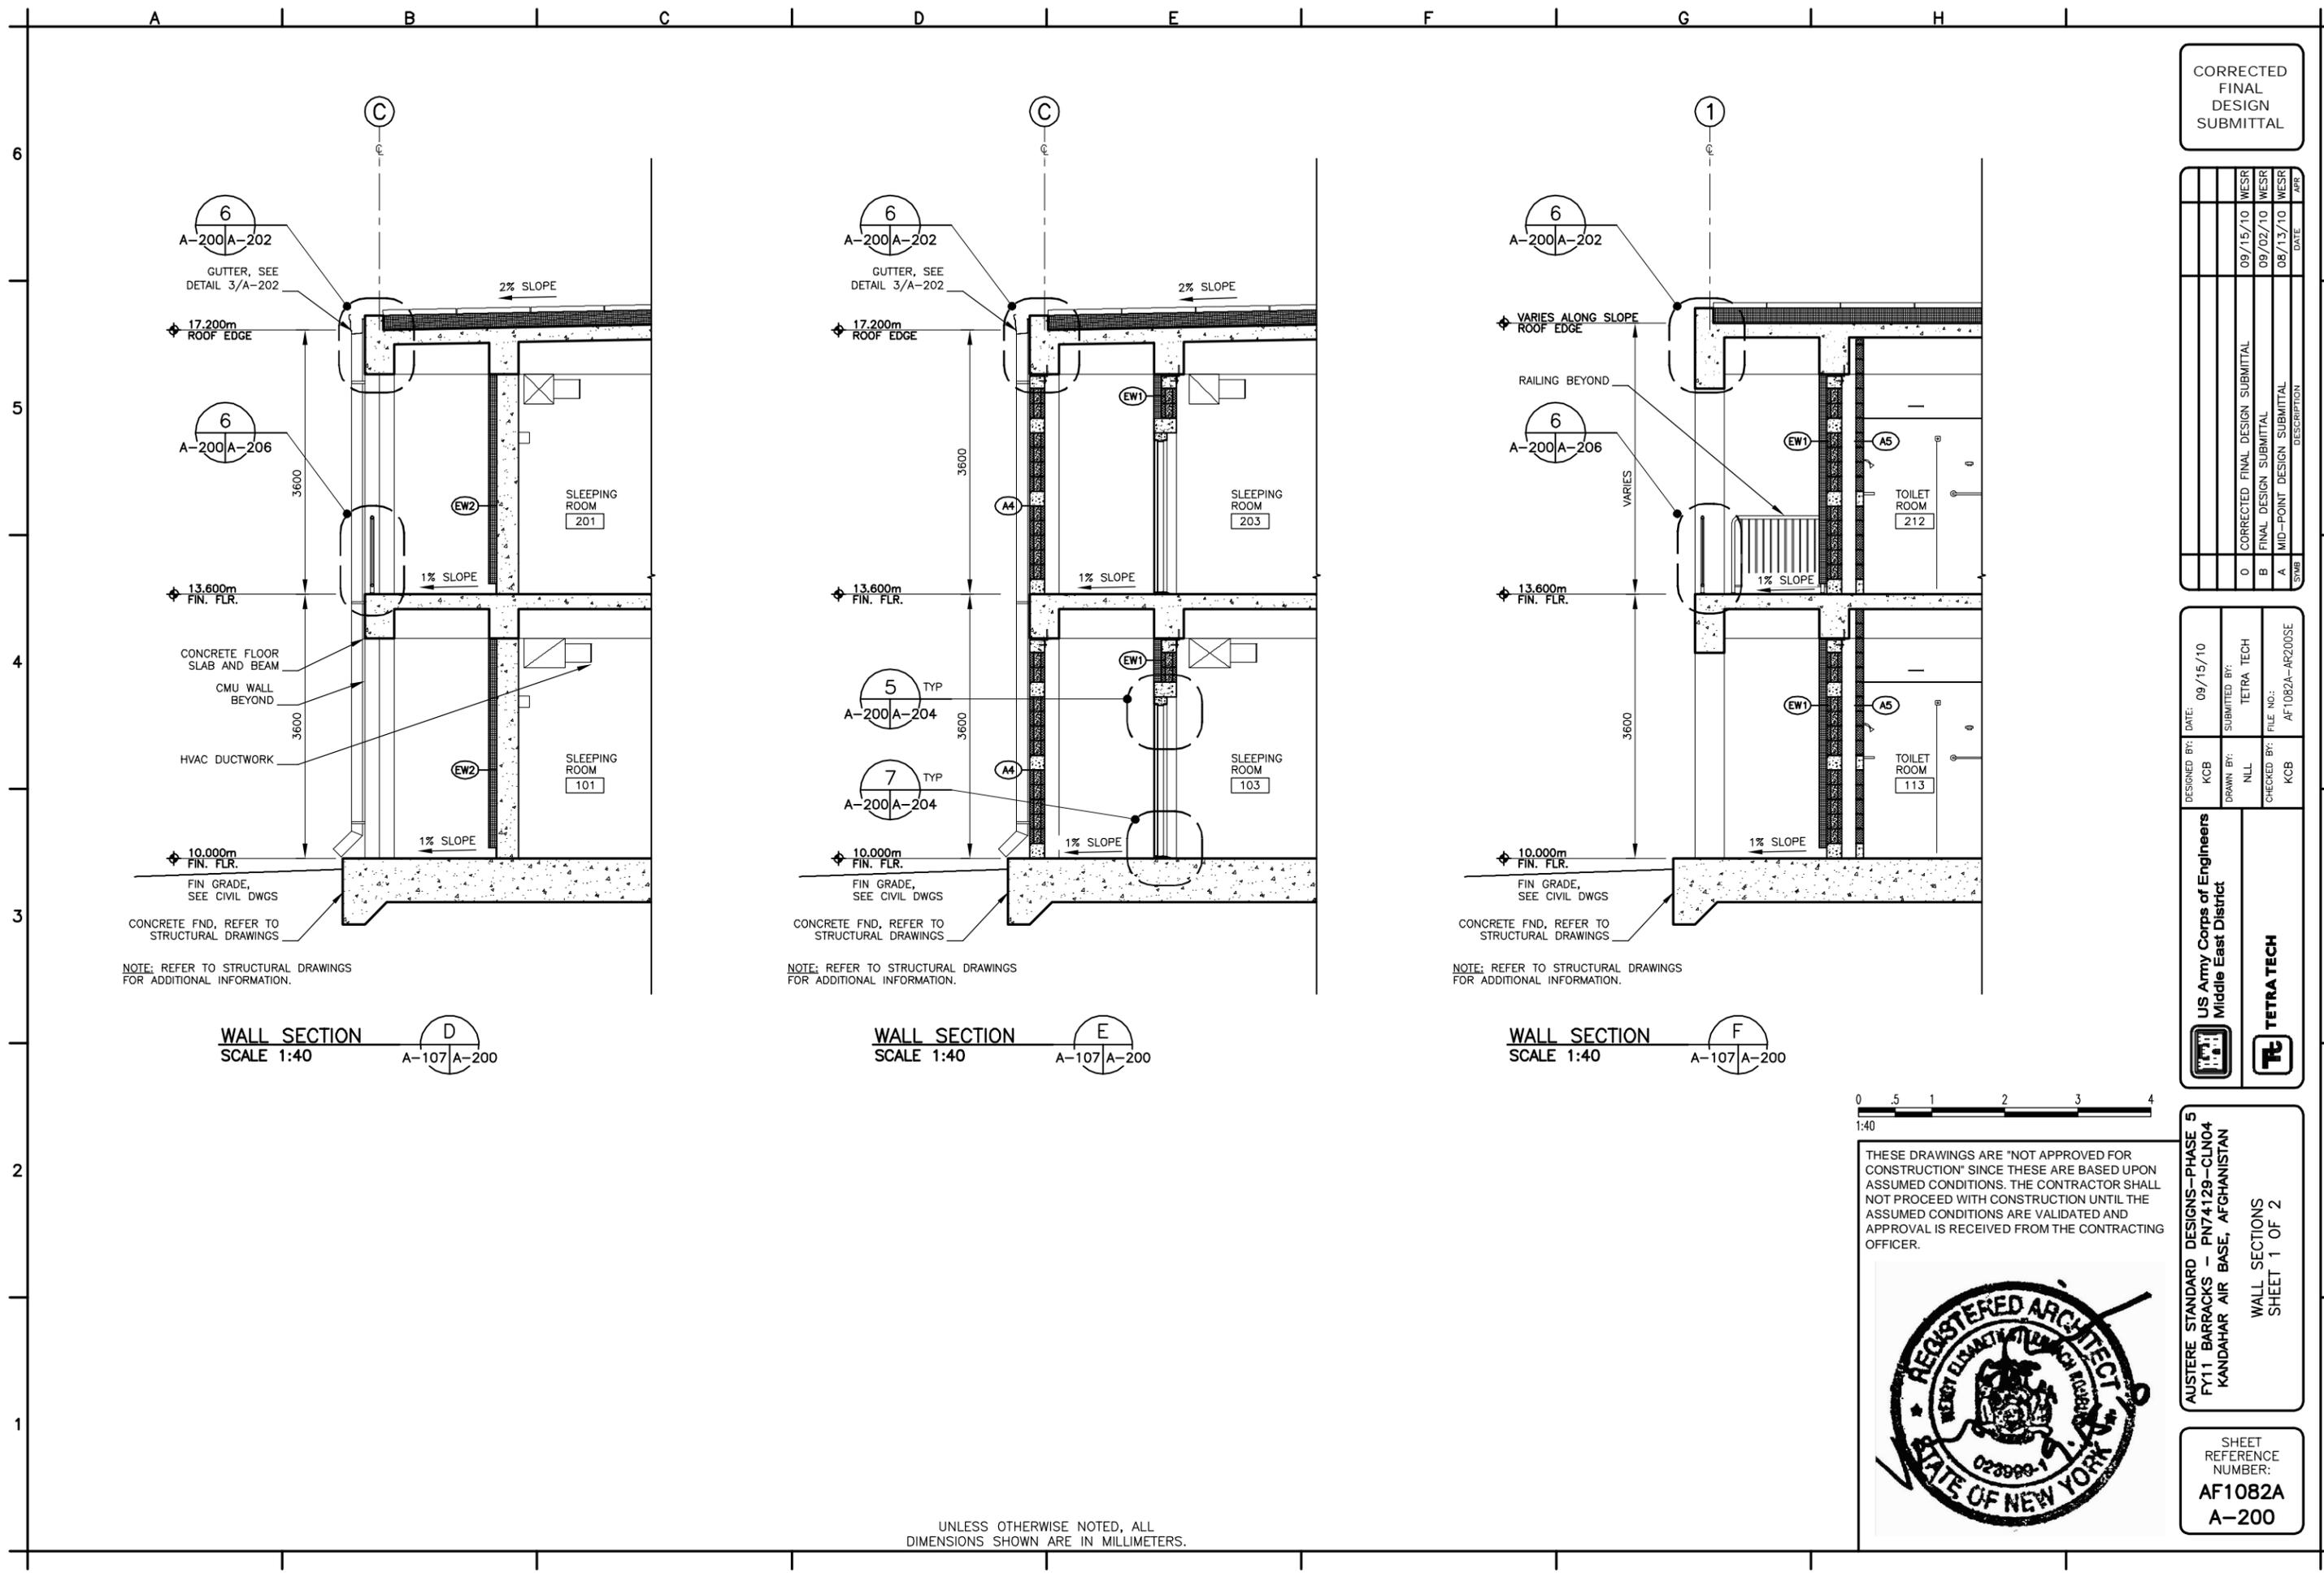
AUSTERE STANDARD DESIGNS - PHASE 5
FY11 BARRACKS - PN74129-CLN04
KANDAHAR AIR BASE, AFGHANISTAN

BUILDING SECTIONS

SHEET
REFERENCE
NUMBER:
AF1082A
A-107

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NOTE: REFER TO STRUCTURAL DRAWINGS FOR ADDITIONAL INFORMATION.

NOTE: REFER TO STRUCTURAL DRAWINGS FOR ADDITIONAL INFORMATION.

NOTE: REFER TO STRUCTURAL DRAWINGS FOR ADDITIONAL INFORMATION.

WALL SECTION D
SCALE 1:40
A-107/A-200

WALL SECTION E
SCALE 1:40
A-107/A-200

WALL SECTION F
SCALE 1:40
A-107/A-200



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AUSTERE STANDARD DESIGNS - PHASE 5
FY11 BARRACKS - PN74129-CLN04
KANDAHAR AIR BASE, AFGHANISTAN

SHEET REFERENCE NUMBER:
**AF1082A
A-200**

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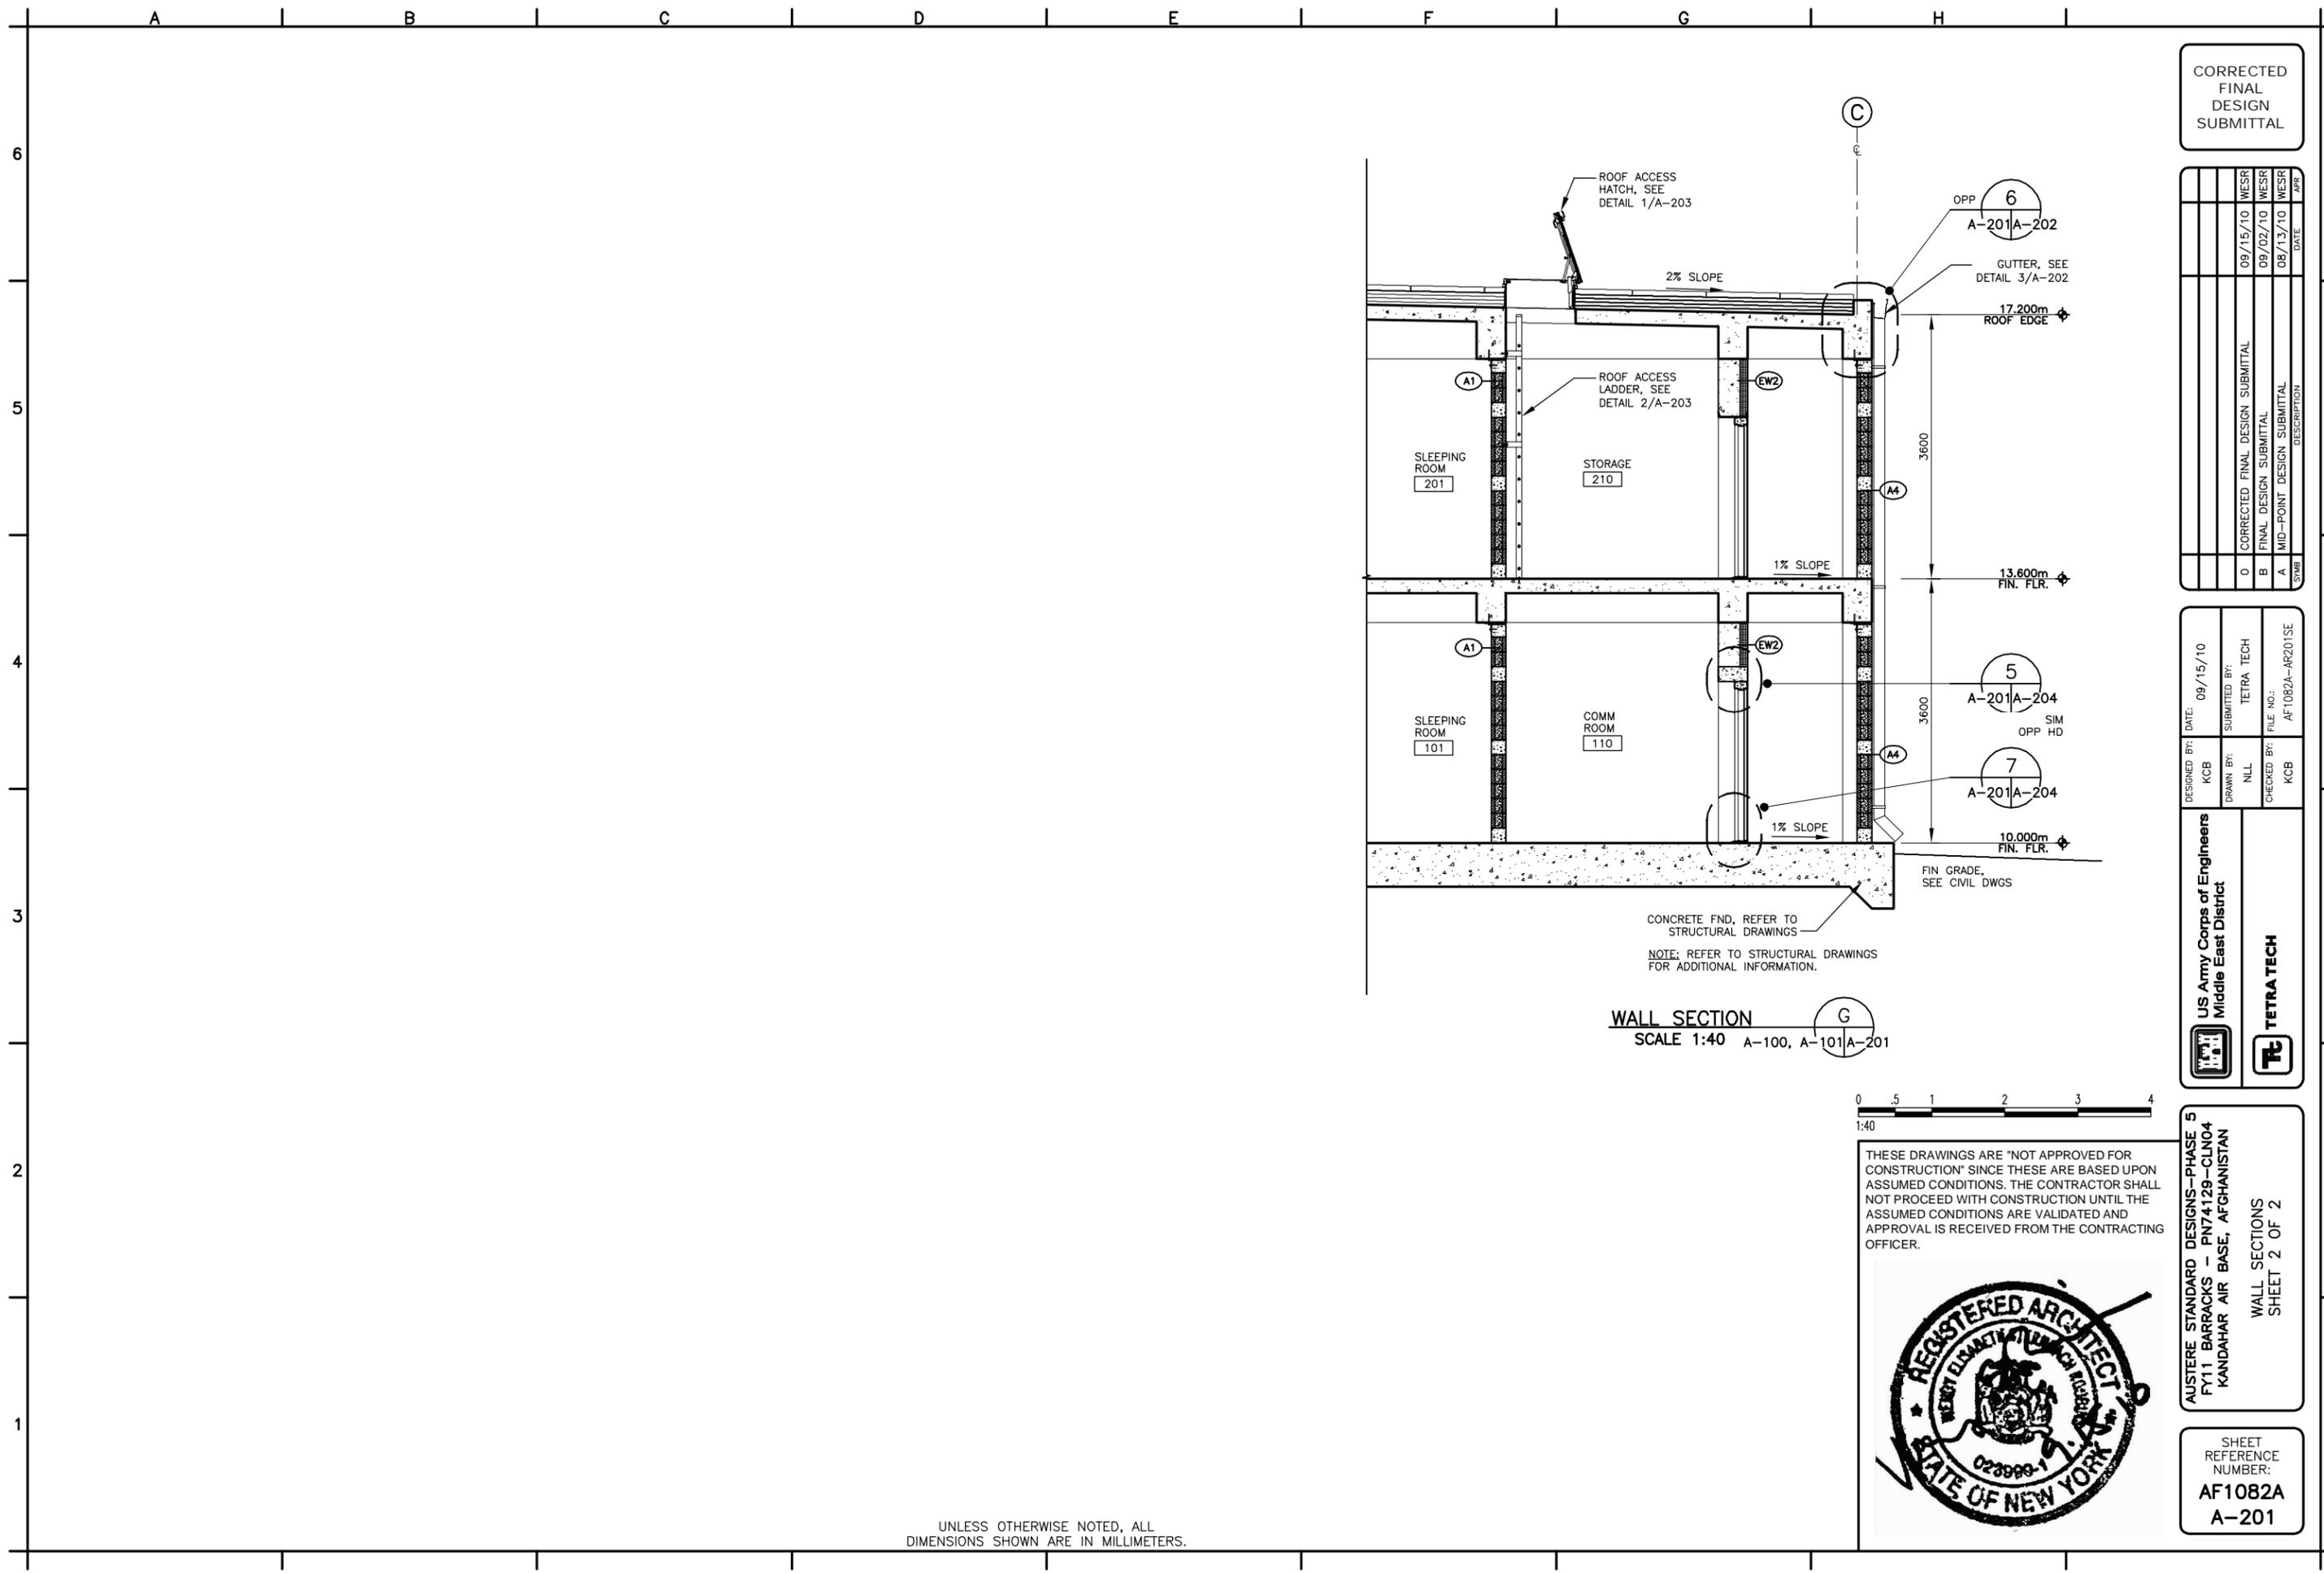
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SYMB	DESCRIPTION	DATE	APP
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B	FINAL DESIGN SUBMITTAL	09/02/10	WESR
A	MID-POINT DESIGN SUBMITTAL	08/13/10	WESR

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DESIGNED BY:	KCB	DATE:	09/15/10
DRAWN BY:	NULL	SUBMITTED BY:	TETRA TECH
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TETRA TECH

AUSTERE STANDARD DESIGNS - PHASE 5
FY11 BARRACKS - PN74129-CLN04
KANDAHAR AIR BASE, AFGHANISTAN




















WALL SECTIONS
SHEET 2 OF 2

SHEET REFERENCE NUMBER:
AF1082A
A-201



UNLESS OTHERWISE NOTED, ALL DIMENSIONS SHOWN ARE IN MILLIMETERS.

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CORRECTED FINAL DESIGN SUBMITTAL

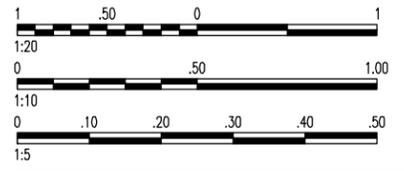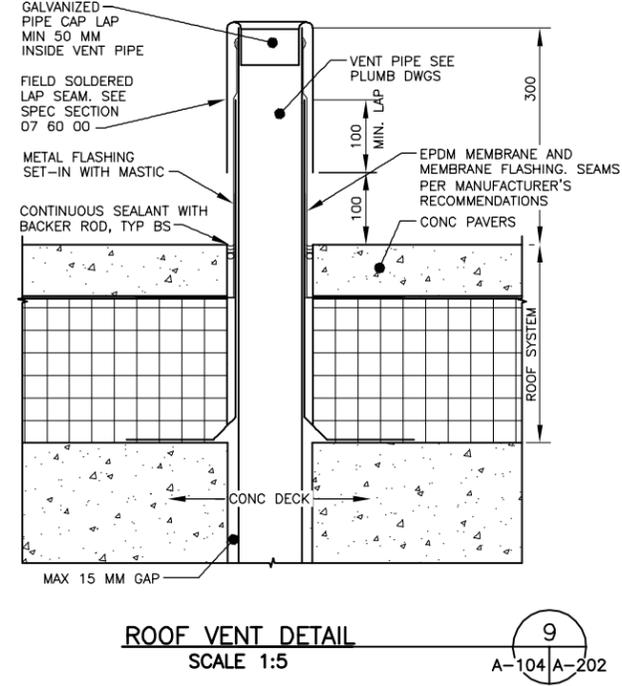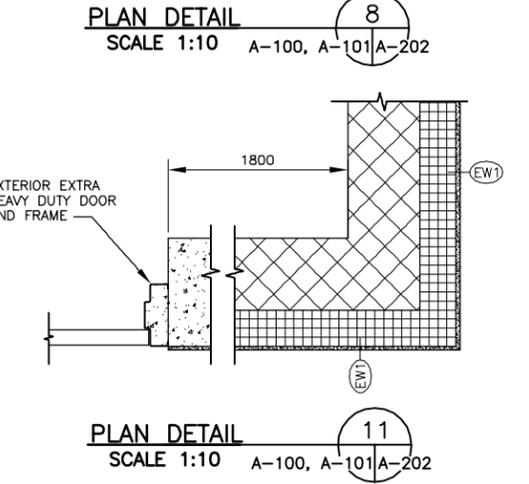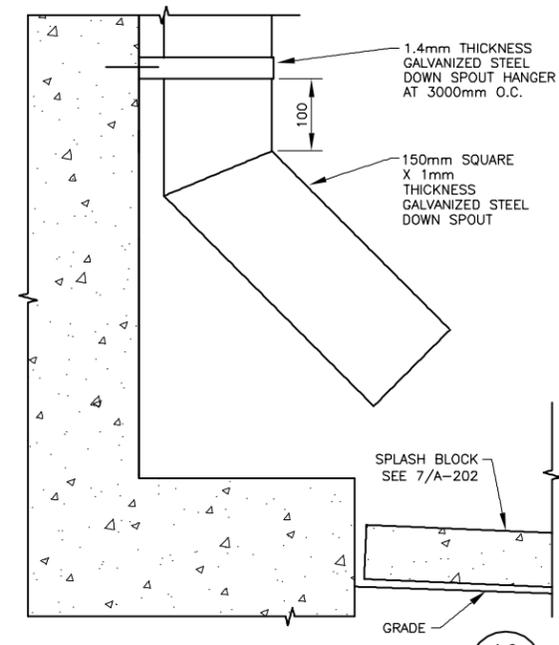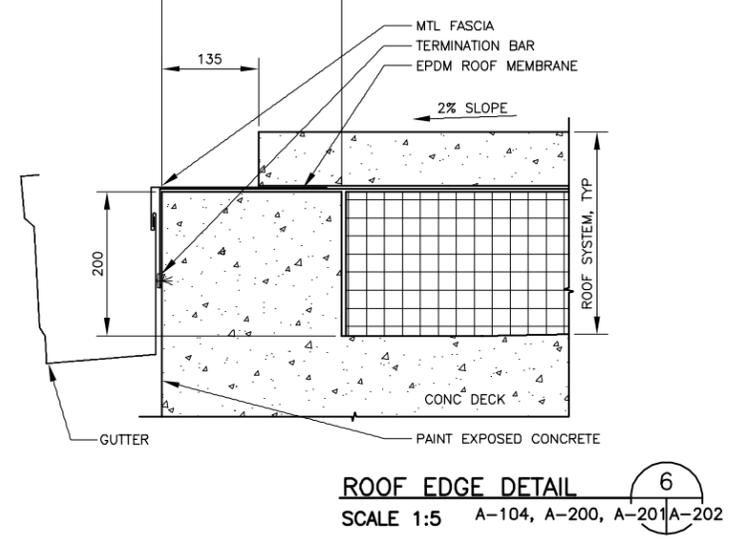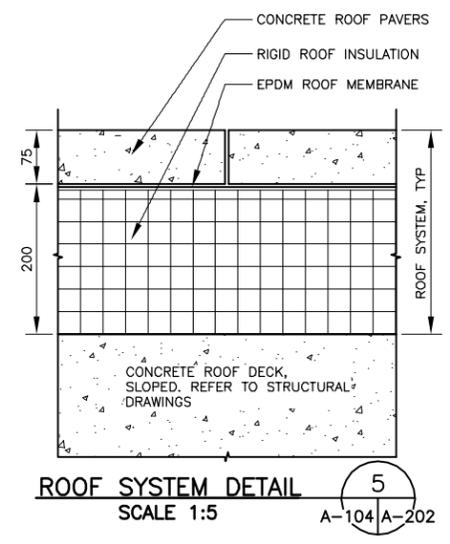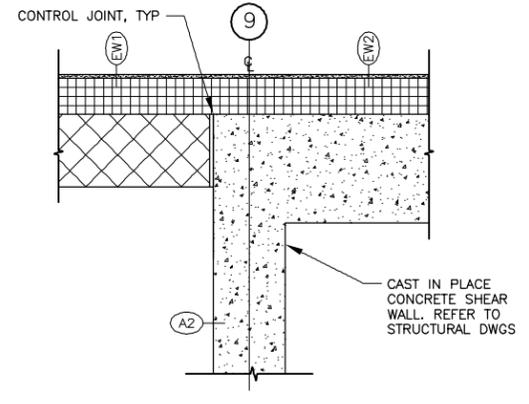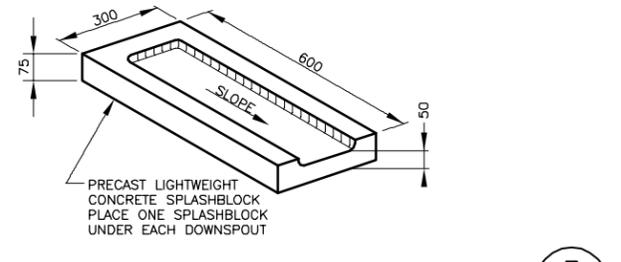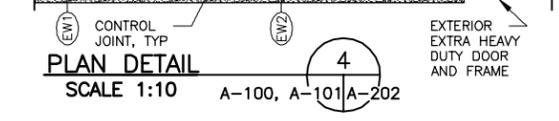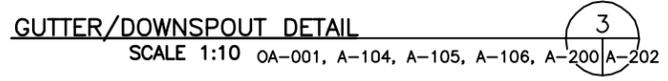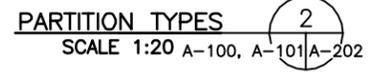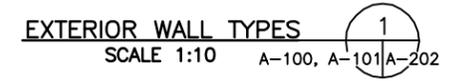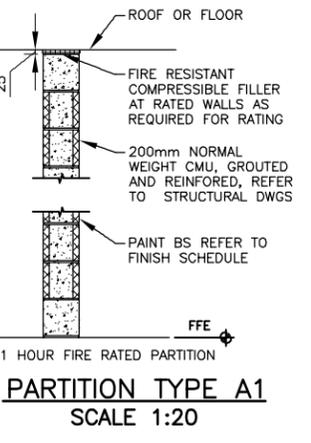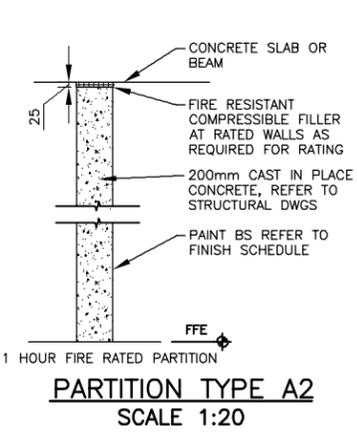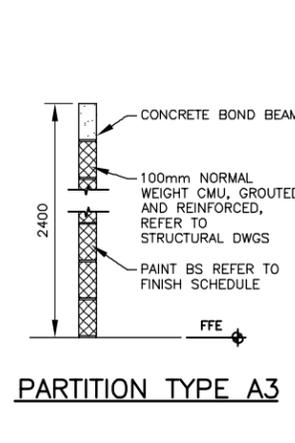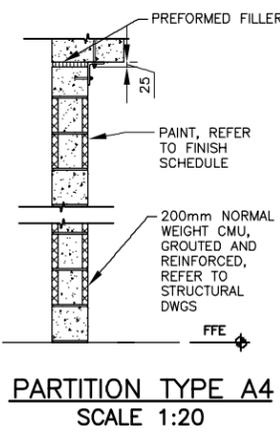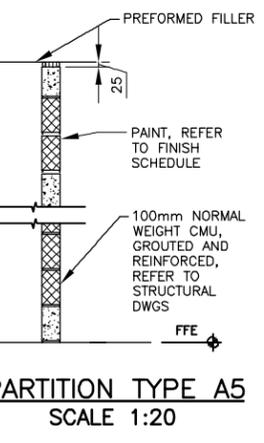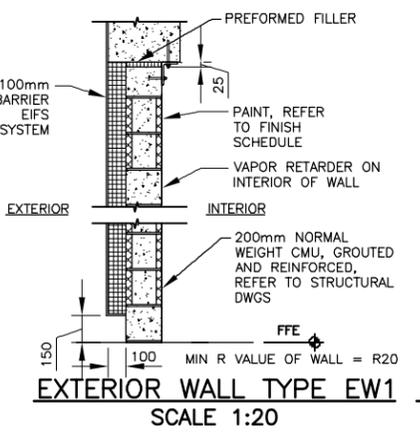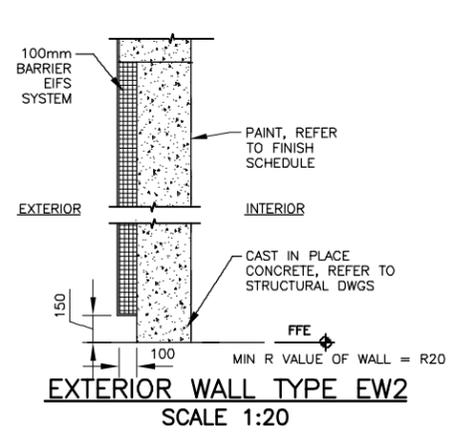NO	DESCRIPTION	DATE	BY
0	CORRECTED FINAL DESIGN SUBMITTAL	09/15/10	WESR
B	FINAL DESIGN SUBMITTAL	09/02/10	WESR
A	MID-POINT DESIGN SUBMITTAL	08/13/10	WESR

DESIGNED BY:	KCB	DATE:	09/15/10
DRAWN BY:	NULL	SUBMITTED BY:	TETRA TECH
CHECKED BY:	KCB	FILE NO.:	AF1082A-AR202D1

US Army Corps of Engineers
Middle East District
TETRA TECH

AUSTERE STANDARD DESIGNS - PHASE 5
FY11 BARRACKS - PN74129-CLN04
KANDAHAR AIR BASE, AFGHANISTAN
MISCELLANEOUS DETAILS
SHEET 1 OF 2


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A-202

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ROOF ACCESS HATCH,
914mm X 914mm
REFER TO SHEET A-105
FOR HATCH LOCATION

FASTEN PER
MANUFACTURER'S
REQUIREMENTS




ROOF HATCH DETAIL
SCALE 1:10
A-104, A-201, A-203 | A-203

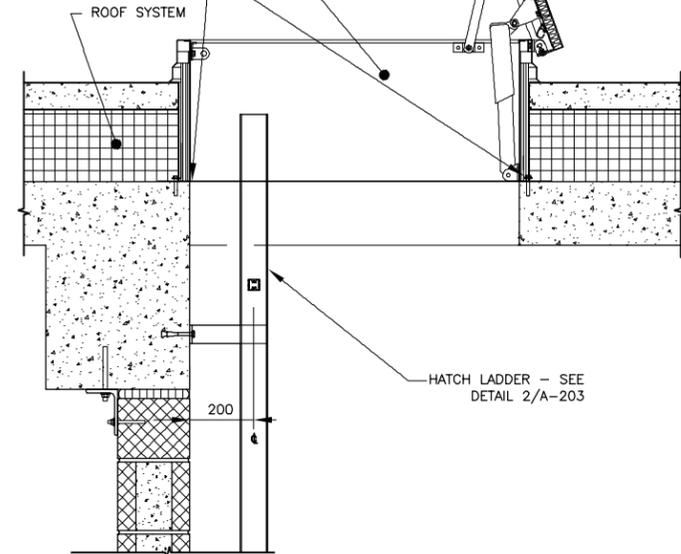METAL COUNTER
FLASHING


EPDM MEMBRANE AND
ADHERED MEMBRANE
FLASHING. SEAMS PER
MANUFACTURER'S
RECOMMENDATIONS

CURB - SECURE TO
CONCRETE DECK, SEE
MECH/STRUC DWGS

CONTINUOUS SEALANT WITH
BACKER ROD, TYP BS

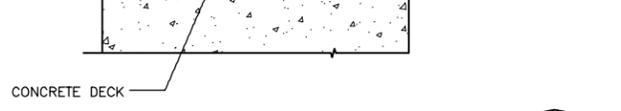


TYPICAL CURB FLASHING DETAIL
SCALE 1:5
M-102, A-104 | A-203

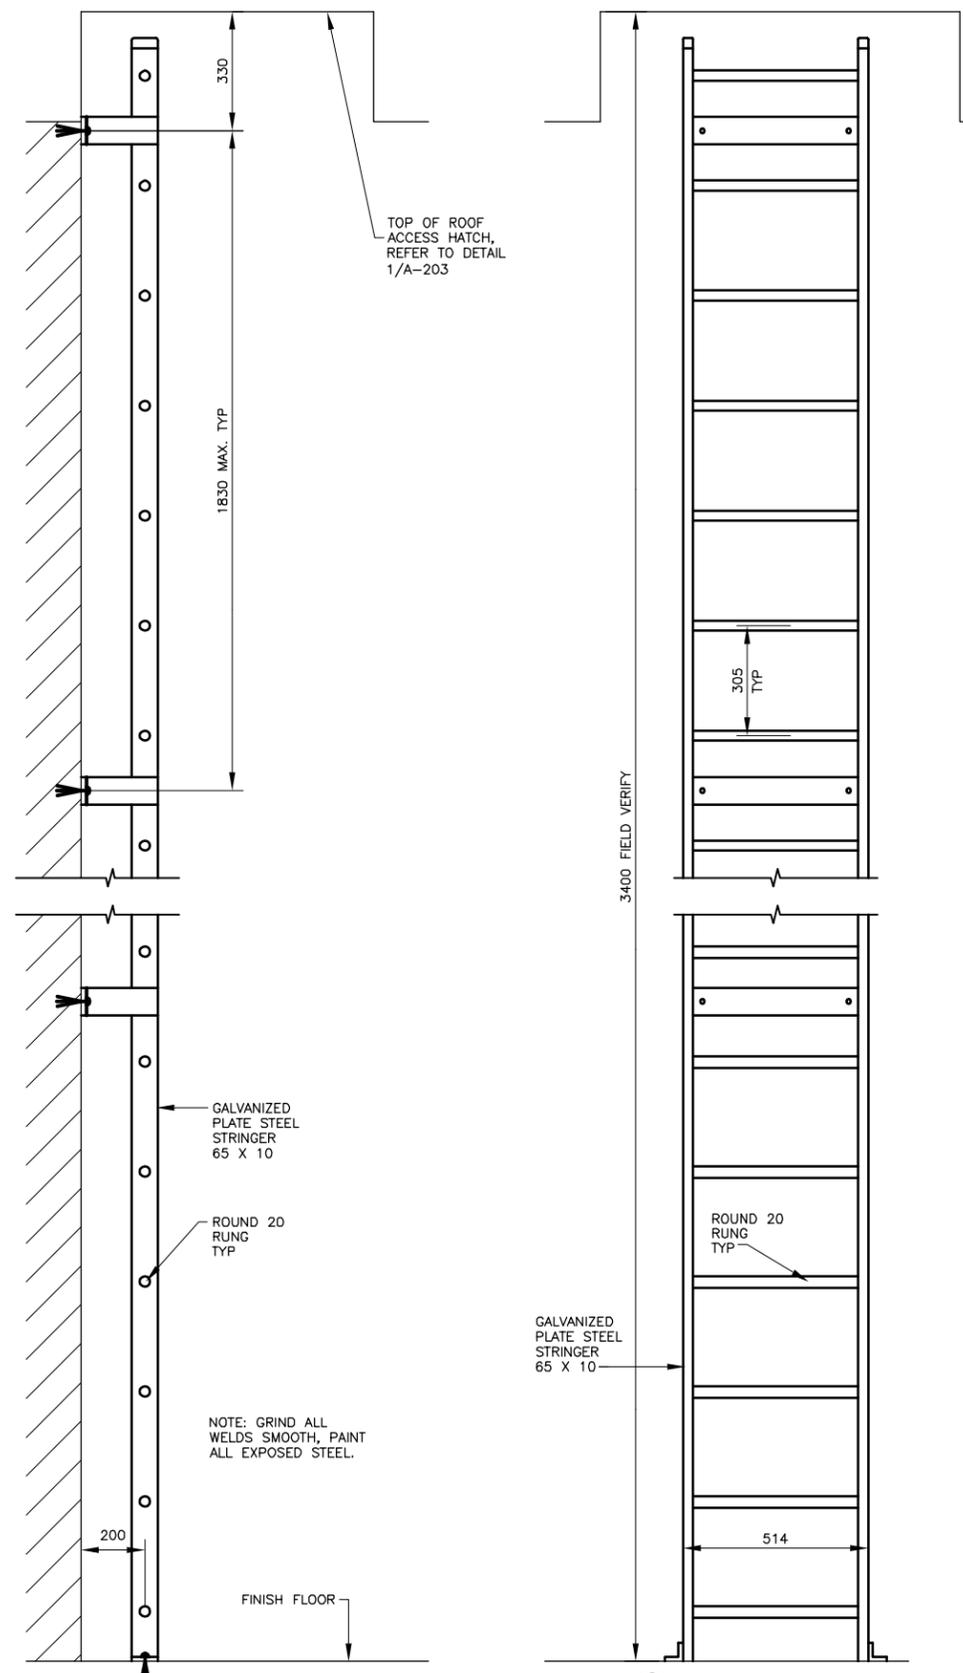


ACCESS LADDER DETAIL
SCALE 1:10
A-101 | A-203


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DIMENSIONS SHOWN ARE IN MILLIMETERS.

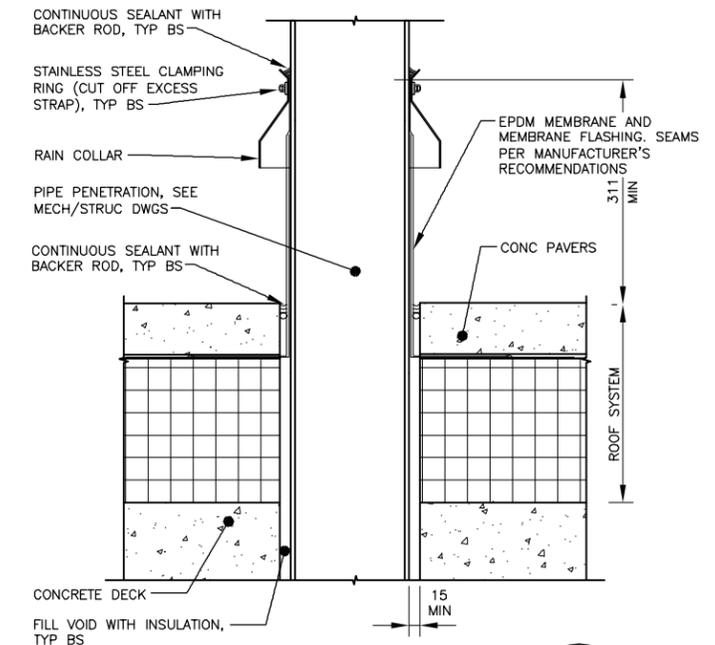

PIPE PENETRATION DETAIL
SCALE 1:5
M-102, A-104 | A-203

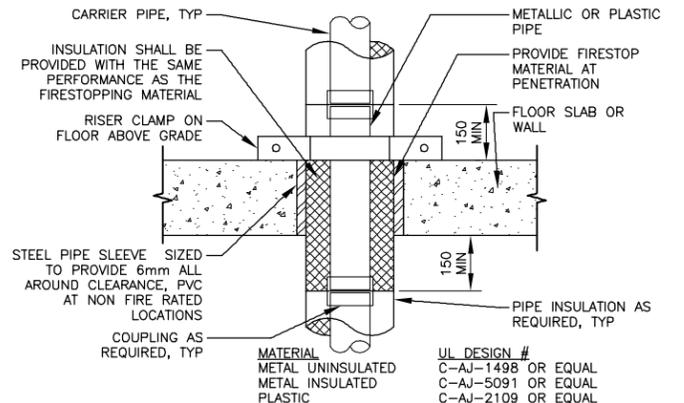

**TYPICAL FIRE-RATED CONC FLOOR AND
CONC OR MAS WALL PENETRATION**
NTS
A-100, A-101 | A-203

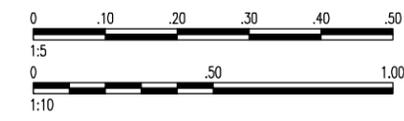

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CORRECTED
FINAL
DESIGN
SUBMITTAL

SYMB	DESCRIPTION	DATE	APP
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B	FINAL DESIGN SUBMITTAL	09/02/10	WESR
A	MID-POINT DESIGN SUBMITTAL	08/13/10	WESR

DESIGNED BY:	KCB	DATE:	09/15/10
DRAWN BY:	NLL	SUBMITTED BY:	TETRA TECH
CHECKED BY:	KCB	FILE NO.:	AF1082A-AR203DT

US Army Corps of Engineers
Middle East District

TETRA TECH

AUSTERE STANDARD DESIGNS - PHASE 5
FY11 BARRACKS - PN74129-CLN04
KANDAHAR AIR BASE, AFGHANISTAN

MISCELLANEOUS DETAILS
SHEET 2 OF 2

SHEET
REFERENCE
NUMBER:
**AF1082A
A-203**

DOOR SCHEDULE

DOOR TAG	DOOR TO ROOM	DOOR TYPE	DOOR MATERIAL	RATING	QTY	WIDTH	HEIGHT	THK	GLAZING	DOOR FRAME				HARD WARE	REMARKS		
										HEAD	JAMB1	JAMB2	SILL				
101	1	SLEEPING ROOM	F	HMD-E	1	900	2100	45	-	STL	AA	5/A-204	6/A-204	-	7/A-204	HWG-1	
101	2	SLEEPING ROOM	F	HMD-E	1	900	2100	45	-	STL	AA	5/A-204	6/A-204	-	7/A-204	HWG-1	
101	3	SLEEPING ROOM	F	HMD-E	1	900	2100	45	-	STL	AA	5/A-204	6/A-204	-	7/A-204	HWG-1	
102	1	SLEEPING ROOM	F	HMD-E	1	900	2100	45	-	STL	AA	5/A-204	6/A-204	-	7/A-204	HWG-1	
102	2	SLEEPING ROOM	F	HMD-E	1	900	2100	45	-	STL	AA	5/A-204	6/A-204	-	7/A-204	HWG-1	
103	1	SLEEPING ROOM	F	HMD-E	1	900	2100	45	-	STL	AA	5/A-204	6/A-204	-	7/A-204	HWG-1	
103	2	SLEEPING ROOM	F	HMD-E	1	900	2100	45	-	STL	AA	5/A-204	6/A-204	-	7/A-204	HWG-1	
104	1	SLEEPING ROOM	F	HMD-E	1	900	2100	45	-	STL	AA	5/A-204	6/A-204	-	7/A-204	HWG-1	
104	2	SLEEPING ROOM	F	HMD-E	1	900	2100	45	-	STL	AA	5/A-204	6/A-204	-	7/A-204	HWG-1	
105	1	SLEEPING ROOM	F	HMD-E	1	900	2100	45	-	STL	AA	5/A-204	6/A-204	-	7/A-204	HWG-1	
105	2	SLEEPING ROOM	F	HMD-E	1	900	2100	45	-	STL	AA	5/A-204	6/A-204	-	7/A-204	HWG-1	
106	1	SLEEPING ROOM	F	HMD-E	1	900	2100	45	-	STL	AA	5/A-204	6/A-204	-	7/A-204	HWG-1	
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108	2	SLEEPING ROOM	F	HMD-E	1	900	2100	45	-	STL	AA	5/A-204	6/A-204	-	7/A-204	HWG-1	
109	1	SLEEPING ROOM	F	HMD-E	1	900	2100	45	-	STL	AA	5/A-204	6/A-204	-	7/A-204	HWG-1	
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110	1	COMM ROOM	F	HMD-E	1	900	2100	45	-	STL	AA	5/A-204	6/A-204	-	7/A-204	HWG-2	
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113	1	TOILET ROOM	F	HMD-E	1	900	2100	45	-	STL	AA	5/A-204	6/A-204	-	7/A-204	HWG-3	
114	1	JANITOR	F.1	HMD	1	720	2100	45	-	STL	BB	3/A-204	4/A-204	-	-	HWG-4	
201	1	SLEEPING ROOM	F	HMD-E	1	900	2100	45	-	STL	AA	5/A-204	6/A-204	-	7/A-204	HWG-1	
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206	1	SLEEPING ROOM	F	HMD-E	1	900	2100	45	-	STL	AA	5/A-204	6/A-204	-	7/A-204	HWG-1	
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212	1	TOILET ROOM	F	HMD-E	1	900	2100	45	-	STL	AA	5/A-204	6/A-204	-	7/A-204	HWG-3	
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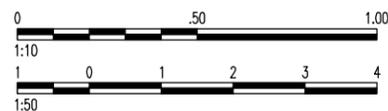
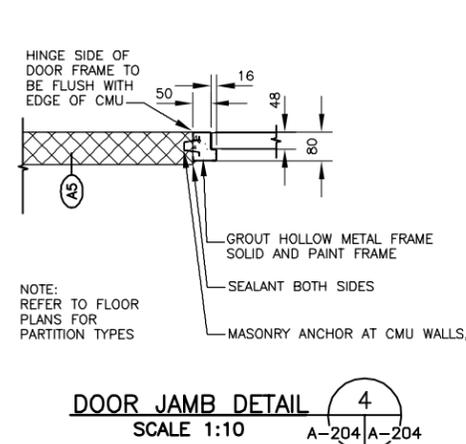
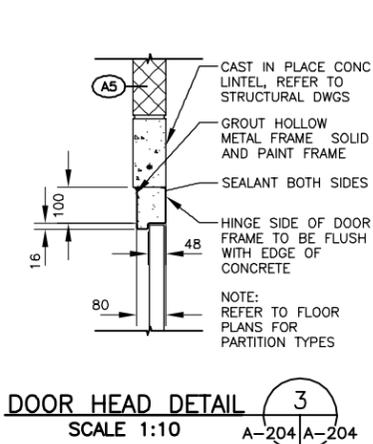
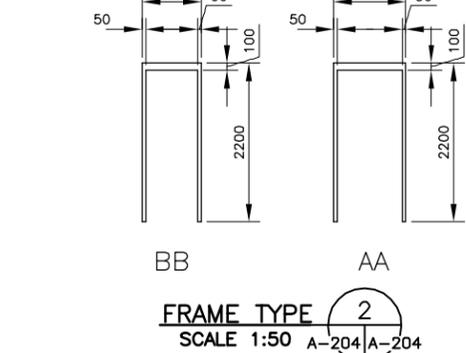
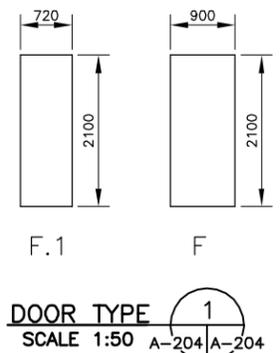
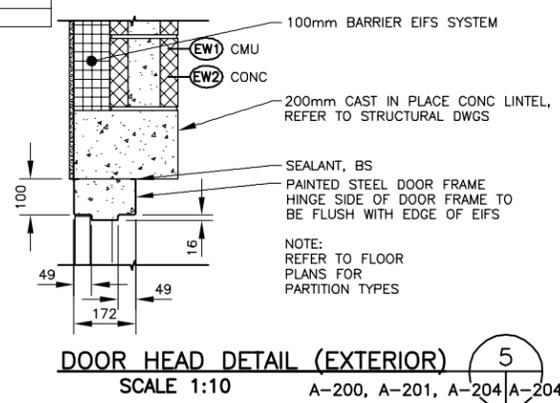
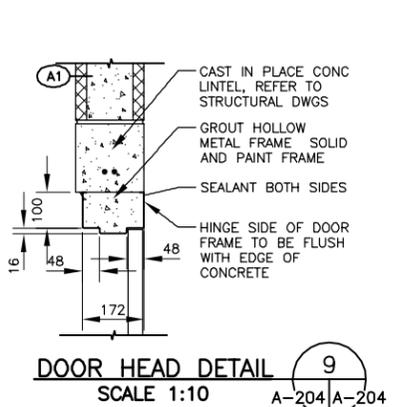
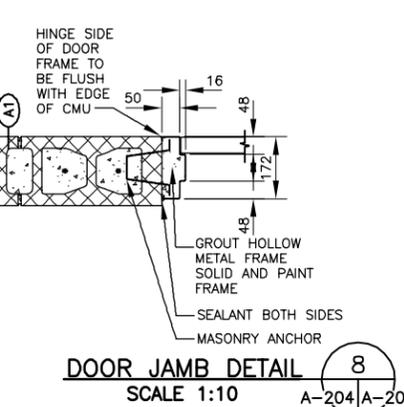
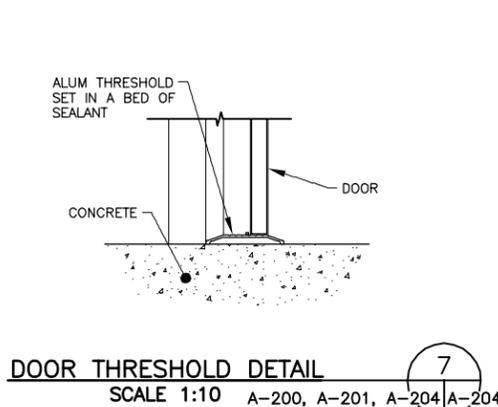
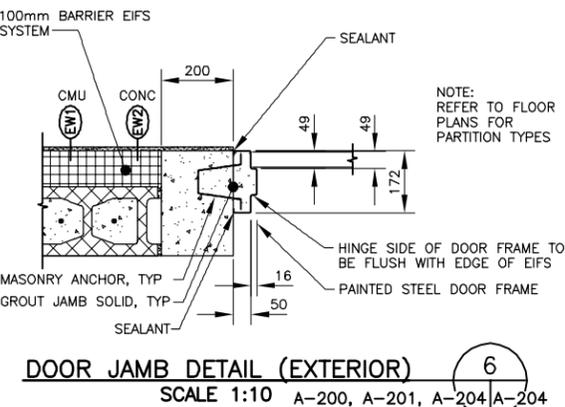
HMD-E = EXTERIOR EXTRA HEAVY DUTY DOORS
HMD = HEAVY DUTY METAL DOORS
REFER TO FRAME TYPES ON 2/A-204
REFER TO DOOR TYPES ON 1/A-204

FINISH SCHEDULE

ROOM NO.	NAME	FLOOR MATERIAL	BASE	WALLS INTERIOR		CEILINGS			REMARKS
				MATERIAL	FINISH	MATERIAL	FINISH	HEIGHT	
101-109	SLEEPING ROOMS	S-CONC	-	CONC, CMU	P	ES	P	BOS	
110	COMM ROOM	S-CONC	-	CONC, CMU	P	ES	P	BOS	
111	ELEC ROOM	S-CONC	-	CONC, CMU	P	ES	P	BOS	
112	MECH ROOM	HPC	-	CONC, CMU	P	ES	P	BOS	NON SLIP
113	TOILET ROOM	HPC	-	CONC, CMU	P	ES	P	BOS	NON SLIP
114	JANITOR	HPC	-	CONC, CMU	P	ES	P	BOS	NON SLIP
201-209	SLEEPING ROOMS	S-CONC	-	CONC, CMU	P	ES	P	BOS	
210	STORAGE ROOM	S-CONC	-	CONC, CMU	P	ES	P	BOS	
211	MECH ROOM	HPC	-	CONC, CMU	P	ES	P	BOS	NON SLIP
212	TOILET ROOM	HPC	-	CONC, CMU	P	ES	P	BOS	NON SLIP
213	JANITOR	HPC	-	CONC, CMU	P	ES	P	BOS	NON SLIP

LEGEND

- BOS Bottom of Structure
 - CONC Concrete
 - S-CONC Sealed Concrete
 - CMU Concrete Masonry Unit
 - FF Factory Finish
 - ES Exposed Structure
 - P Paint
 - HPC High Performance Coating
- GENERAL NOTE:
1. ALL DOORS, DOOR FRAMES, AND TRIM TO RECEIVE P
2. PAINT ALL EXPOSED STRUCTURE.
3. PAINT EXPOSED SIDE OF CHASE WALL ONLY. INTERIOR SIDE OF CHASE WALL DOES NOT RECEIVE PAINT.



CORRECTED FINAL DESIGN SUBMITTAL

NO.	DESCRIPTION	DATE	BY
0	CORRECTED FINAL DESIGN SUBMITTAL	09/15/10	WESR
B	FINAL DESIGN SUBMITTAL	09/02/10	WESR
A	MID-POINT DESIGN SUBMITTAL	08/13/10	WESR

DESIGNED BY:	KCB	DATE:	09/15/10
DRAWN BY:	NLL	SUBMITTED BY:	TETRA TECH
CHECKED BY:	KCB	FILE NO.:	AF1082A-AR204SC

US Army Corps of Engineers
Middle East District

TETRA TECH

AUSTERE STANDARD DESIGNS - PHASE 5
FY11 BARRACKS - PN74129-CLN04
KANDAHAR AIR BASE, AFGHANISTAN

DOOR DETAILS,
DOOR AND FINISH
SCHEDULES




SHEET REFERENCE NUMBER:
**AF1082A
A-204**

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(STAIR 2 SIM) STAIR 1 - SECTION H
SCALE 1:50 A-105, A-106, A-205 A-205

(STAIR 2 SIM) STAIR 1 - SECTION J
SCALE 1:50 A-205 A-205

STAIR 1 - FIRST FLOOR ENLARGED PLAN
(STAIR 2 - SIMILAR) SCALE 1:50 A-205 A-205

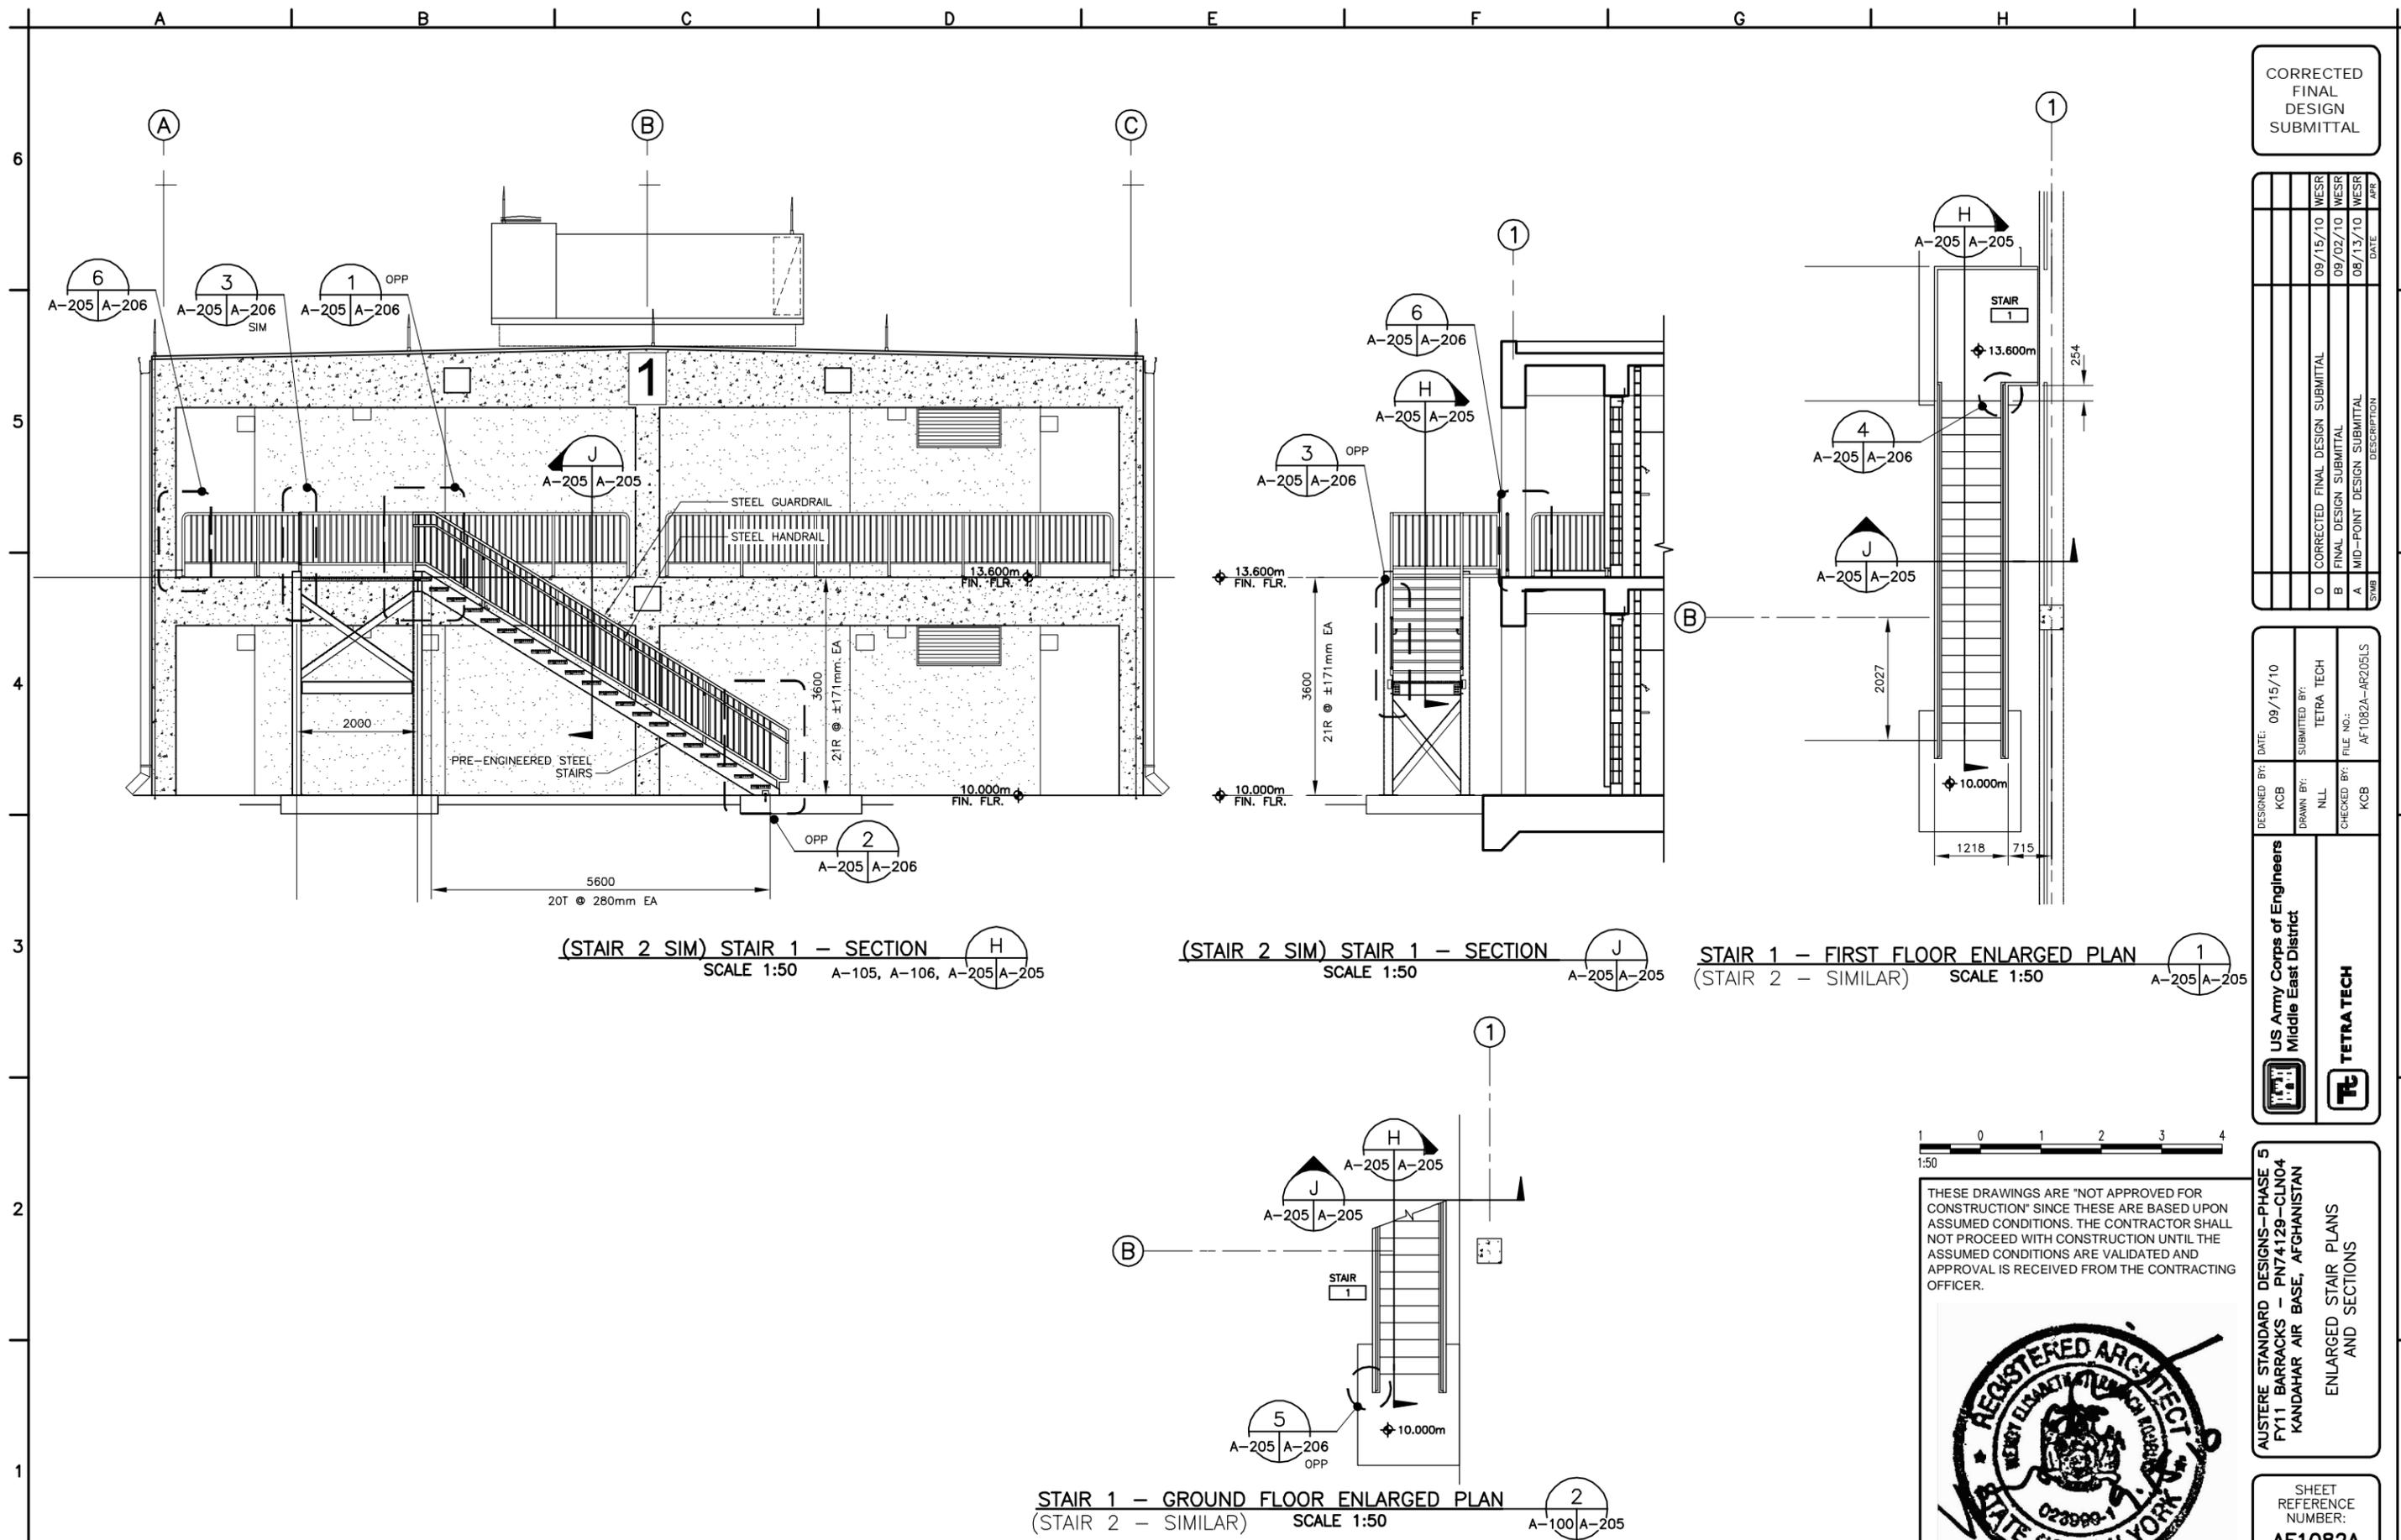STAIR 1 - GROUND FLOOR ENLARGED PLAN
(STAIR 2 - SIMILAR) SCALE 1:50 A-100 A-205



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DESIGNED BY:	KCB	DATE:	09/15/10
DRAWN BY:	NLL	SUBMITTED BY:	TETRA TECH
CHECKED BY:	KCB	FILE NO.:	AF1082A-AR205LS

US Army Corps of Engineers
Middle East District

TETRA TECH


AUSTERE STANDARD DESIGNS - PHASE 5
FY11 BARRACKS - PN74129-CLN04
KANDAHAR AIR BASE, AFGHANISTAN

ENLARGED STAIR PLANS AND SECTIONS


SHEET REFERENCE NUMBER:
AF1082A
A-205

UNLESS OTHERWISE NOTED, ALL DIMENSIONS SHOWN ARE IN MILLIMETERS.


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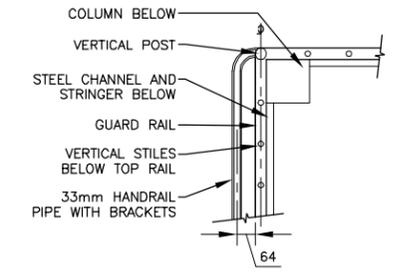
STAIR HEADER DETAIL 1
SCALE 1:10 A-205 A-206

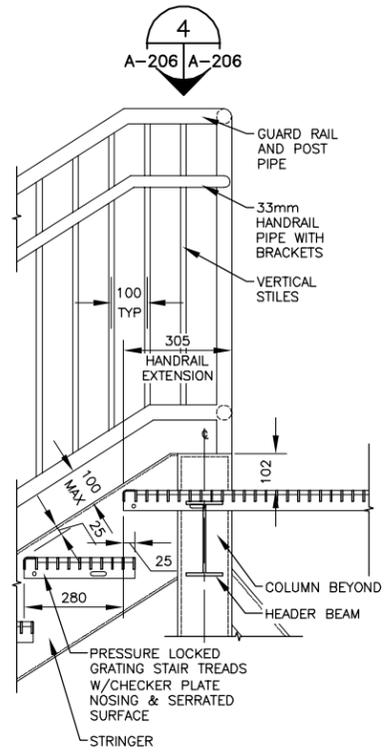


STAIR BASE DETAIL 2
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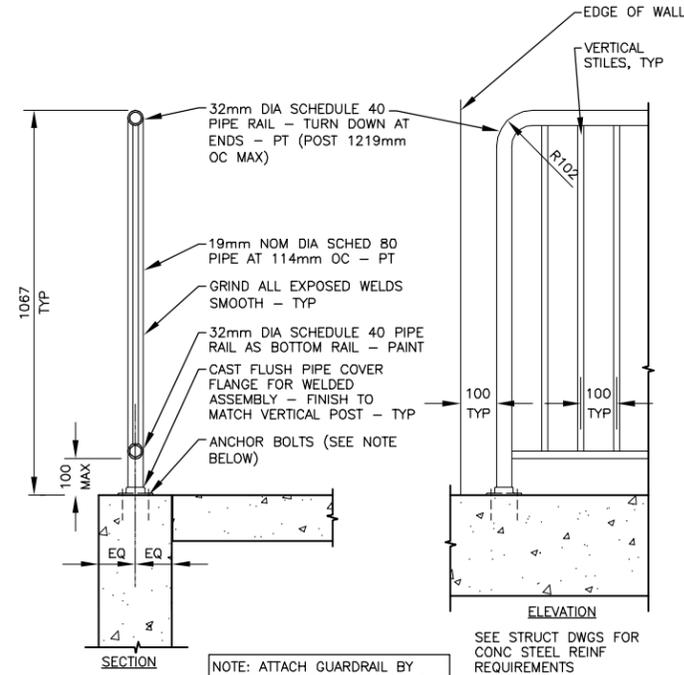
GUARDRAIL DETAIL 3
SCALE 1:10 A-205 A-206

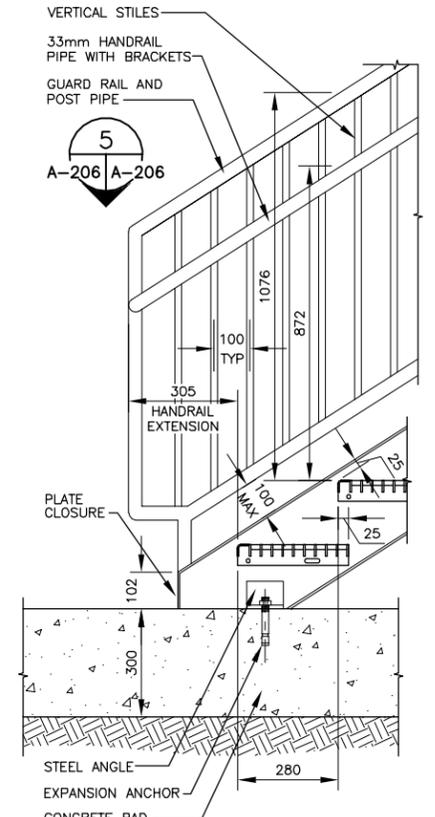

HANDRAIL DETAIL 4
SCALE 1:10 A-205, A-206 A-206

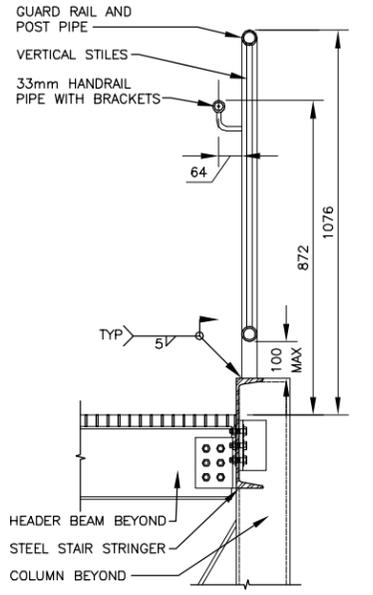


HANDRAIL DETAIL 5
SCALE 1:5 A-205, A-206 A-206

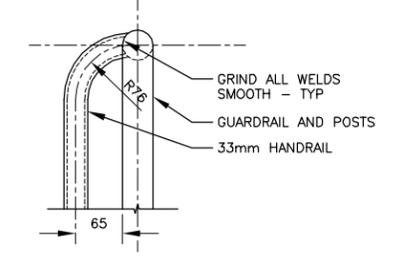

GUARDRAIL DETAIL 6
SCALE 1:10 A-101, A-106, A-200, A-205 A-206

NOTE: ATTACH GUARDRAIL BY MEANS OF ANCHOR BOLTING INTO THE CONCRETE TO MEET LOAD REQUIREMENTS PER SPEC SECTION 05 52 00

SEE STRUCT DWGS FOR CONC STEEL REINF REQUIREMENTS

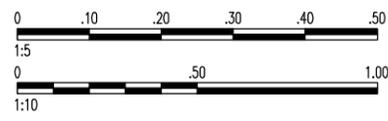

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SYMB	DESCRIPTION	DATE	APP
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B	FINAL DESIGN SUBMITTAL	09/02/10	WESR
A	MID-POINT DESIGN SUBMITTAL	08/13/10	WESR

DESIGNED BY:	KCB	DATE:	09/15/10
DRAWN BY:	NULL	SUBMITTED BY:	TETRA TECH
CHECKED BY:	KCB	FILE NO.:	AF1082A-AR206DT

US Army Corps of Engineers
Middle East District

TETRA TECH

AUSTERE STANDARD DESIGNS-PHASE 5
FY11 BARRACKS - PN74129-CLN04
KANDAHAR AIR BASE, AFGHANISTAN

STAIR DETAILS


SHEET REFERENCE NUMBER:
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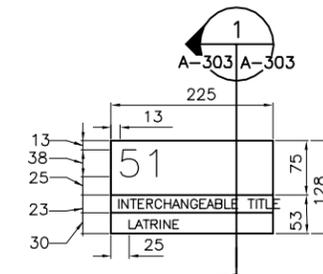
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EXTERIOR SIGNAGE SCHEDULE					
NO.	ROOM NAME	SIGN TYPE	QTY	SIGNAGE TEXT	NOTES
TBD	NUMBER TBD	5	2	BUILDING IDENTIFICATION	REFER TO EXTERIOR ELEVATIONS
TBD	TBD	3	2	BUILDING IDENTIFICATION	LOCATED TBD IN FIELD
INTERIOR SIGNAGE SCHEDULE					
NO.	ROOM NAME	SIGN TYPE	QTY	SIGNAGE TEXT	NOTES
101	SLEEPING ROOM	2/4	3	ROOM NAME	ADJACENT TO DOOR 101/1, 101/2, 101/3
102	SLEEPING ROOM	2/4	2	ROOM NAME	ADJACENT TO DOOR 102/1, 102/2
103	SLEEPING ROOM	2/4	2	ROOM NAME	ADJACENT TO DOOR 103/1, 103/2
104	SLEEPING ROOM	2/4	2	ROOM NAME	ADJACENT TO DOOR 104/1, 104/2
105	SLEEPING ROOM	2/4	2	ROOM NAME	ADJACENT TO DOOR 105/1, 105/2
106	SLEEPING ROOM	2/4	2	ROOM NAME	ADJACENT TO DOOR 106/1, 106/2
107	SLEEPING ROOM	2/4	2	ROOM NAME	ADJACENT TO DOOR 107/1, 107/2
108	SLEEPING ROOM	2/4	2	ROOM NAME	ADJACENT TO DOOR 108/1, 108/2
109	SLEEPING ROOM	2/4	2	ROOM NAME	ADJACENT TO DOOR 109/1, 109/2
110	COMM ROOM	2/4	1	ROOM NAME	ADJACENT TO DOOR 110/1
111	ELEC ROOM	2/4	1	ROOM NAME	ADJACENT TO DOOR 111/1
112	MECH ROOM	2/4	1	ROOM NAME	ADJACENT TO DOOR 112/1
113	TOILET ROOM	1	1	ROOM NAME	ADJACENT TO DOOR 113/1
114	JANITOR	2	1	ROOM NAME	ADJACENT TO DOOR 114/1
201	SLEEPING ROOM	2/4	3	ROOM NAME	ADJACENT TO DOOR 201/1, 201/2, 201/3
202	SLEEPING ROOM	2/4	2	ROOM NAME	ADJACENT TO DOOR 202/1, 202/2
203	SLEEPING ROOM	2/4	2	ROOM NAME	ADJACENT TO DOOR 203/1, 203/2
204	SLEEPING ROOM	2/4	2	ROOM NAME	ADJACENT TO DOOR 204/1, 204/2
205	SLEEPING ROOM	2/4	2	ROOM NAME	ADJACENT TO DOOR 205/1, 205/2
206	SLEEPING ROOM	2/4	2	ROOM NAME	ADJACENT TO DOOR 206/1, 206/2
207	SLEEPING ROOM	2/4	2	ROOM NAME	ADJACENT TO DOOR 207/1, 207/2
208	SLEEPING ROOM	2/4	2	ROOM NAME	ADJACENT TO DOOR 208/1, 208/2
209	SLEEPING ROOM	2/4	2	ROOM NAME	ADJACENT TO DOOR 209/1, 209/2
210	STORAGE ROOM	2/4	1	ROOM NAME	ADJACENT TO DOOR 210/1
211	MECH ROOM	2/4	1	ROOM NAME	ADJACENT TO DOOR 211/1
212	TOILET ROOM	1	1	ROOM NAME	ADJACENT TO DOOR 212/1
213	JANITOR	2	1	ROOM NAME	ADJACENT TO DOOR 213/1

NOTE:
LOCATIONS OF TYPE 4 EXTINGUISHER SIGNAGE IS SHOWN ON LS-DRAWINGS.




ROOM IDENTIFICATION
SIGNS TYPE 2
SCALE 1:5

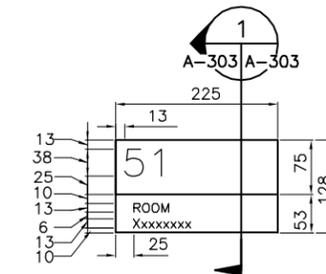


REST ROOM SIGNS TYPE 1
SCALE 1:5


NOTE: COORDINATE WITH BASE ENGINEER AND CONTRACTING OFFICER AS TO CORRECT BUILDING ROOM NAMES, NUMBERS AND LABEL FOR INTERCHANGEABLE SIGN.

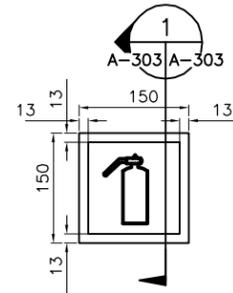


EXTINGUISHER SIGN TYPE 4
SCALE 1:5

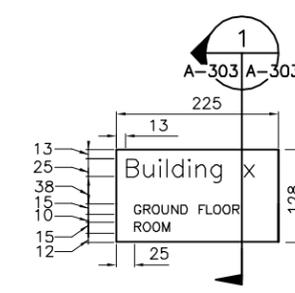

BUILDING IDENTIFICATION
SIGNS TYPE 3
SCALE 1:5

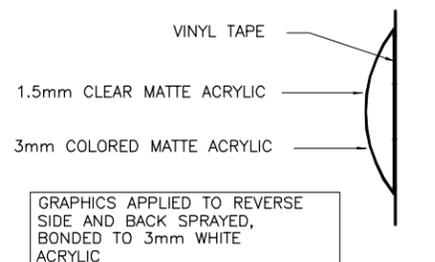


SIGN SECTION
SCALE 1:5

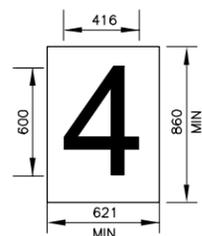


EXTERIOR BUILDING SIGNAGE TYPE 5
SCALE 1:20

NOTE:
REFER TO EXTERIOR ELEVATIONS FOR EXTERIOR BUILDING SIGNAGE LOCATIONS— CENTER BUILDING NUMBER IN PLAQUE.

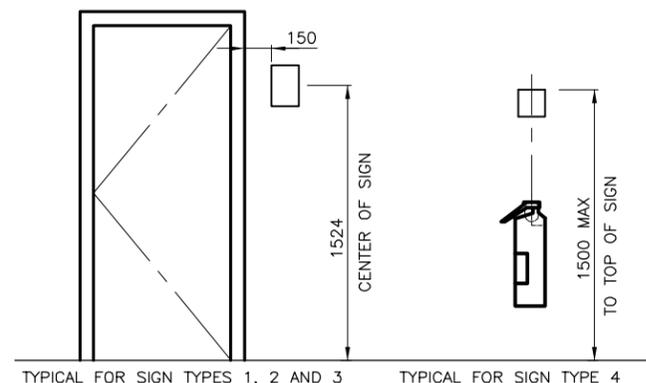

MOUNTING HEIGHTS — IDENTIFICATION SIGNS
SCALE 1:20

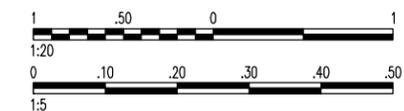

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CORRECTED
FINAL
DESIGN
SUBMITTAL

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DESIGNED BY:	KCB	DATE:	09/15/10
DRAWN BY:	NULL	SUBMITTED BY:	TETRA TECH
CHECKED BY:	KCB	FILE NO.:	AF1082A-AR303DT

US Army Corps of Engineers
Middle East District

TETRA TECH


AUSTERE STANDARD DESIGNS—PHASE 5
FY11 BARRACKS — PN74129—CLN04
KANDAHAR AIR BASE, AFGHANISTAN

SIGNAGE DETAILS


SHEET
REFERENCE
NUMBER:
AF1082A
A-303

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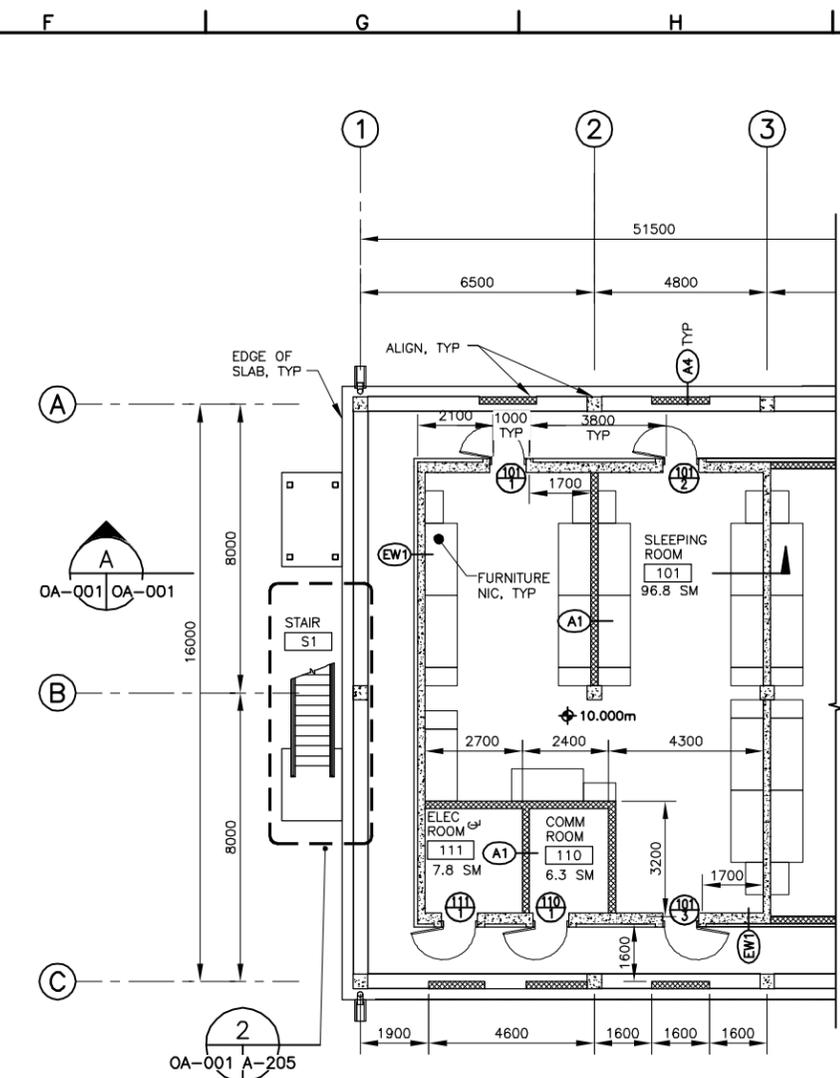
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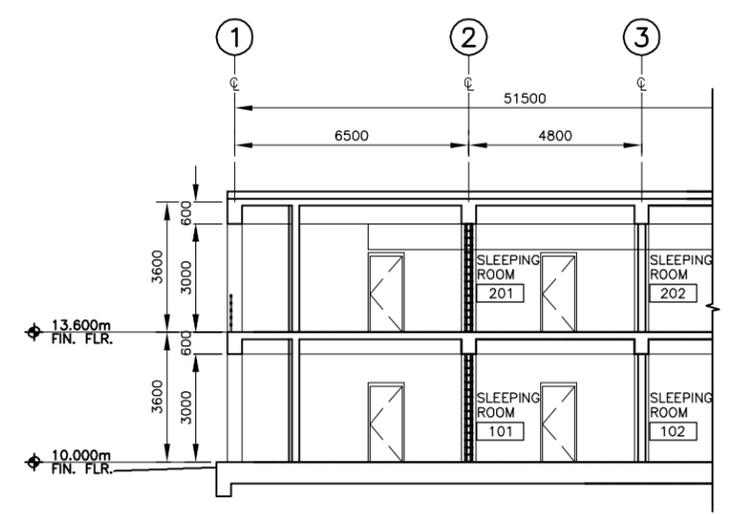
ROOF PLAN
SCALE 1:100
OA-Q01 OA-Q01

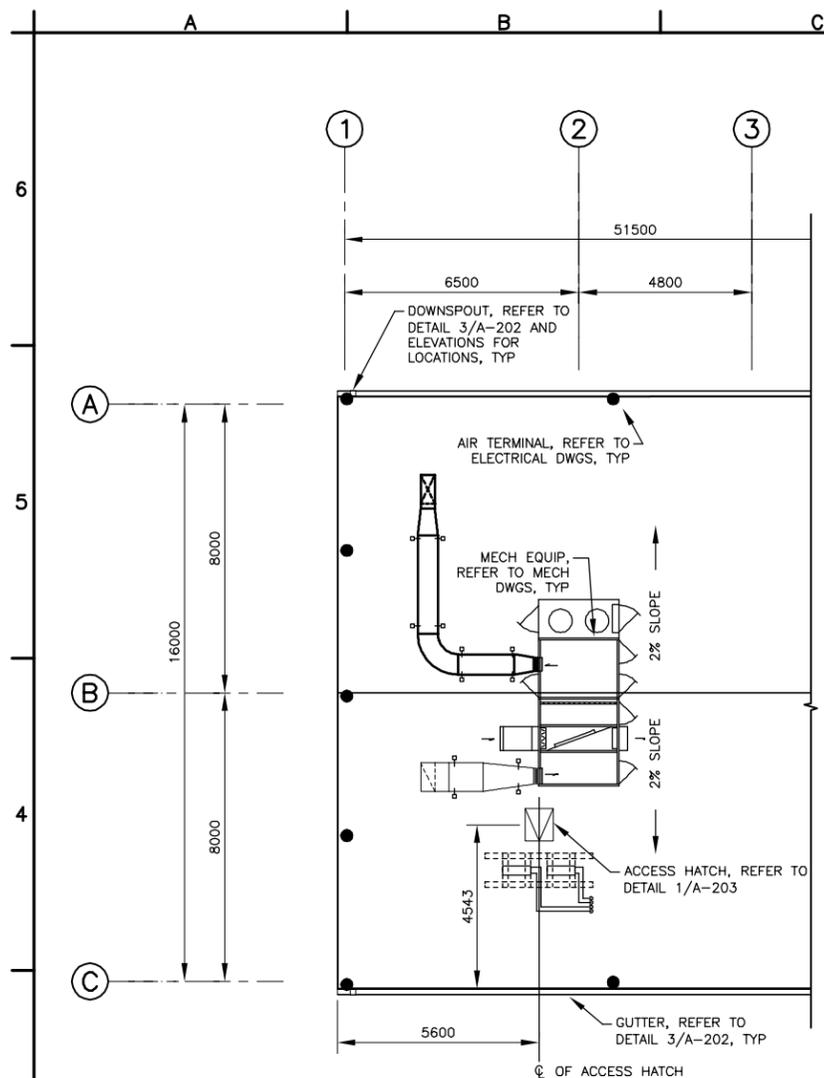

FIRST FLOOR PLAN
SCALE 1:100
OA-Q01 OA-Q01

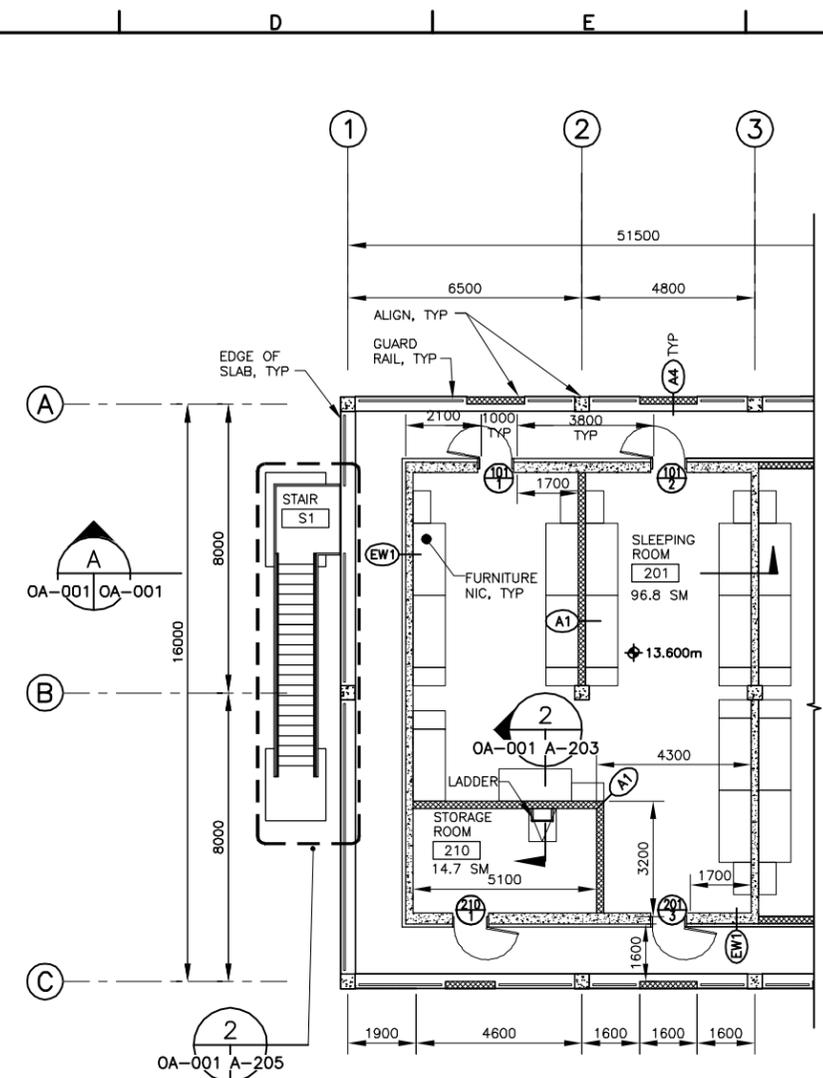

GROUND FLOOR PLAN
SCALE 1:100
OA-Q01 OA-Q01




PARTIAL SECTION
SCALE 1:100
OA-Q01 OA-Q01

UNLESS OTHERWISE NOTED, ALL DIMENSIONS SHOWN ARE IN MILLIMETERS.

GENERAL NOTES:

- UNO, ALL MASONRY/ROUGH OPENINGS FOR DOORS ARE 100mm FROM FACE OF MASONRY.
- REFER TO DRAWING A-202 FOR WALL TYPE AND PARTITION TYPE DETAILS.

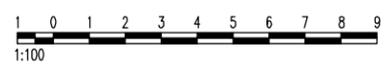

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DESIGNED BY:	KCB	DATE:	09/15/10
DRAWN BY:	NLL	SUBMITTED BY:	TETRA TECH
CHECKED BY:	KCB	FILE NO.:	AF1082A-OAR001PN

US Army Corps of Engineers
Middle East District

TETRA TECH

AUSTERE STANDARD DESIGNS - PHASE 5
FY11 BARRACKS - PN74129-CLN04
KANDAHAR AIR BASE, AFGHANISTAN

ARCHITECTURAL
LATRINE DELETION OPTION

SHEET REFERENCE NUMBER:
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OA-001